


LOWER LEVEL FLOOR PLAN

NOTE: Any field work that might result in deviation from the Designer's plans shall be brought to the attention of the Designer in writing. The Designer assumes no responsibility for any changes to these construction documents that were not approved in writing by the Designer

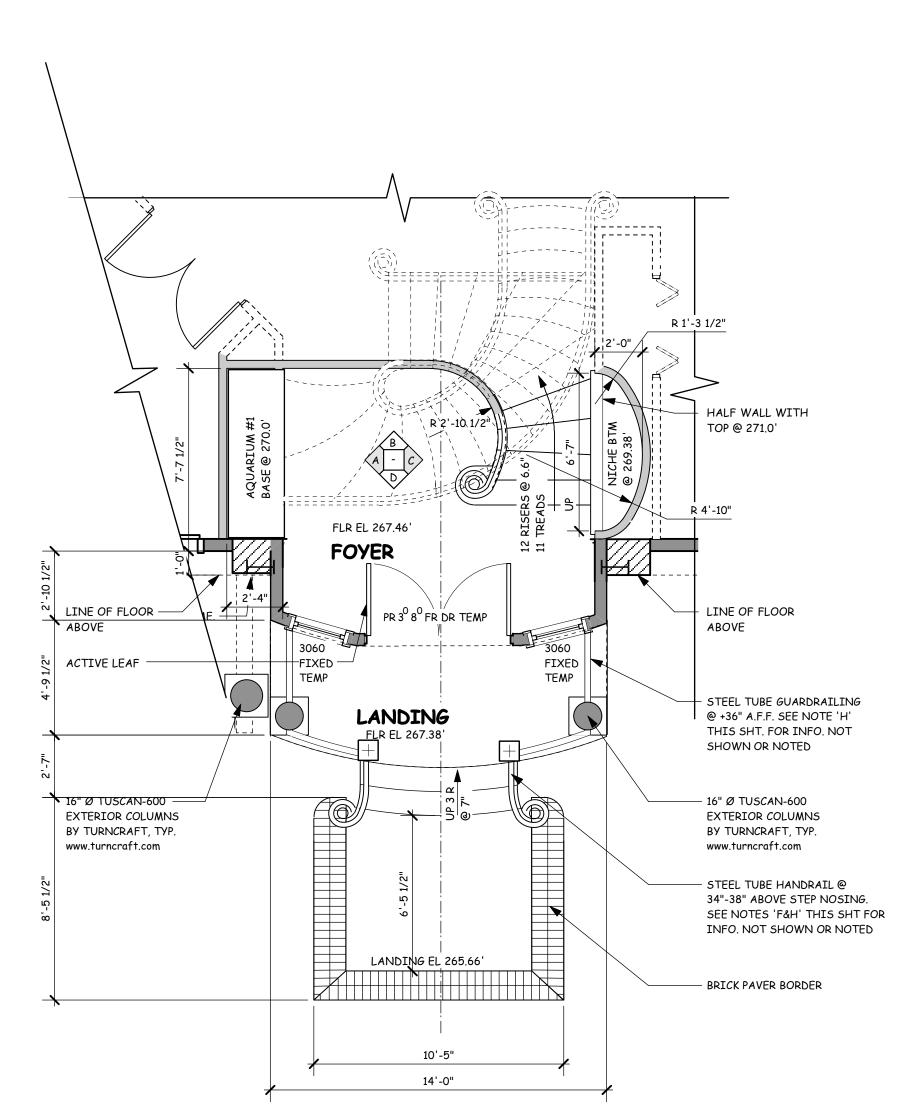

STAIRWAYS & HANDRAILS

STAIRWAYS & HANDRAILS SHALL COMPLY WITH UBC SECTIONS 1003.3.3.6 & 509. A. STAIRWAYS SHALL BE: 36" MIN. WITH THE MAXIMUM RISER HEIGHT OF 7 3/4" AND THE MIN. TREAD DEPTH OF 10", AND 6'-8" MIN. HEADROOM. THE GREATEST RISER HEIGHT OR TREAD DEPTH SHALL NOT EXCEED THE SMALLEST BY MORE THAN 3/8". B. LANDINGS: SAME AS STAIRWAY WIDTH OR 44" MAX.

C. HANDRAILS: NOT REQUIRED FOR LESS THAN FOUR RISERS. HANDRAILS SHALL HAVE A MIN. HEIGHT OF 34" AND A MAX. HEIGHT OF 38" ON AT LEAST ONE SIDE OF STAIRWAYS OF THREE OR MORE RISERS - HANDRAILS SHALL BE CONTINUOUS THE FULL LENGTH OF STAIRS. RETURNED ENDS OR IN SAFETY TERMINALS. 11/4" TO 2" HANDGRIP.

D. OPEN SIDE OF STAIRWAY & GUARDRAIL PROTECTION: WHEN AREA IS MORE THAN 30" ABOVE GRADE OR FLOOR, IT SHALL BE PROTECTED BY A MINIMUM 36" HIGH GUARDRAIL WITH INTERMEDIATE RAILS SUCH THAT A 4" DIAMETER SPHERE CANNOT PASS THROUGH. E. ENCLOSED USABLE AREA UNDER STAIRWAY TO BE PROTECTED WITH 5/8" TYPE

'X' GYP. BOARD.

F. HANDRAILS SHALL BE DESIGNED SUCH THAT THE MAXIMUM CONCENTRATED LOAD SHALL NOT EXCEED 200 LBS., AND THE MAXIMUM UNIFORM LOAD SHALL NOT EXCEED 20 LBS. PER LINEAL FOOT.

G. PROVIDE FIRE STOPPING BETWEEN STAIR STRINGERS AT TOP & BOTTOM AND BETWEEN STUDS ALONG AND INLINE WITH RUN OF STAIR ADJIONING STUD WALLS AND PARTITIONS. WHERE THERE IS AN ENCLOSED USABLE SPACE UNDER THE STAIRS, THE WALLS AND SOFFITS ON THE SPACE SHALL BE PROTECTED WITH 5/8" TYPE 'X' GYP BRD FOR A ONE- HOUR FIRE RESISTIVE CONSTRUCTION PER UBC 1003.3.3.9

H. GUARDRAILS AND HANDRAILS SHALL BE CONSTRUCTED SUCH THAT A SPHERE 4" IN DIA. CANNOT PASS THROUGH RAILINGS. GUARDRAILS SHALL BE A MINIMMUM OF 36" IN HEIGHT. THE TOP OF THE GUARDRAILS SHALL BE ABLE TO SUPPORT A LATERAL FORCE OF 20 POUNDS PER LINEAR FOOT PER UBC TABLE 16-B.

WATER HEATER SEISMIC ANCHORING

WATER HEATER SEISMIC STRAPPING SHALL COMPLY WITH 1997 UPC SECTION 510.5.

A. STRAPS SHALL BE AT THE UPPER ONE-THIRD AND LOWER ONE-THIRD OF ITS VERTICAL DIMENSIONS.

B. AT LOWER POINT, MAINTAIN A MINIMUM OF 4" ABOVE THE CONTROLS WITH THE STRAPPING.

SPECIAL NOTES

NOTE; 1) BUILDER TO CONTACT WINDOW SUPPLIER (EAGLE WINDOWS & DOORS) FOR ROUGH OPENING SIZES

2) BUILDER TO VERIFY ALL EXISTING CONDITIONS AND DIMENSIONS PRIOR TO START OF ANY WORK.

MANDATORY NOTES:

- A. WOODEN BACKING (2X8 MIN.) SHALL BE PROVIDED IN ALL BATHROOM WALLS AT WATER CLOSET, SHOWER AND BATHTUB, LOCATED @ 34" FROM THE FLOOR TO THE CENTER OF THE BACKING, SUITABLE FOR THE ADDITION OF GRAB BARS.
- B. ALL PASSAGE DOORS SHALL BE AT LEAST 32" WIDE ON ACCESSIBLE FLOOR.
- C. PRIMARY ENTRANCE SHALL HAVE A 36" WIDE DOOR INCLUDING: A 5' X 5' LEVEL LANDING NO MORE THAN 1" OUT OF THE PLANE WITH THE IMMEDIATE INTERIOR FLOOR LEVEL, WITH AN 18" CLEARANCE AT INTERIOR STRIKE EDGE.

D. DOOR BUZZER, BELL OR CHIME SHALL BE HARD WIRED.

- E. ALL SHOWERS AND TUBS TO HAVE A PRESSURE BALANCE OR THERMOSTATIC MIXING VALVE PER UPC SECT. 410.7 F. ALL WATER CLOSETS SHALL BE 1.6 GAL./FLUSH MAX.
- G. EXHAUST FANS CONNECTED DIRECTLY TO THE OUTSIDE CAPABLE OF PROVIDING 5 AIR CHANGES PER HOUR SHALL BE PROVIDED AT BATH AND/OR LAUNDRY ROOM WITH VENTILATION DISCHARGE AT A MINIMUM OF 3 FEET FROM ANY OPENING PER SECT, 1203.3 PROVIDE WITH BACK DRAFT DAMPERS PER LOCAL REQUIREMENTS

FOYER LEVEL PLAN

SCALE: 1/4" = 1'-0"

CODE COMPLIANCE

1. ALL GLAZING IN HAZARDOUS LOCATIONS AS PER CODE SHALL BE TEMPERED. SEE FLOOR PLAN FOR LOCATIONS.

2. OPENINGS BETWEEN THE GARAGE AND RESIDENCE SHALL BE EQUIPPED WITH EITHER SOLID WOOD DOORS NOT LESS THAN 1 3/8" IN THICKNESS OR 20-MINUTE FIRE-RATED DOORS & SELF-CLOSING.

3. WHERE WINDOWS ARE PROVIDED AS A MEANS OF EGRESS OR RESCUE THEY SHALL HAVE A SILL HEIGHT OF NOT MORE THAN 44" ABOVE THE FLOOR.

4. ALL EGRESS OR RESCUE WINDOWS FROM SLEEPING ROOMS MUST HAVE A NET CLEAR OPENING OF 5.7 S.F. THE MIN. NET CLEAR OPENING HEIGHT SHALL BE 24". THE MIN. NET CLEAR OPENING WIDTH SHALL BE 20".

5. SHOWER AND BATH AREA WALLS SHALL BE FINISHED WITH A NON ABSORBENT SURFACE SUCH AS C.TILE TO A HEIGHT OF 70" MIMIMUM ABOVE DRAIN INLET U.N.O. . APPLY TILE TO WATER RESISTANT GYP. BRD DIRECTLY TO THE STUDS, PER UBC 807.1.3.

6. A READILY ACCESSIBLE ATTIC ACCESS FRAMED OPENING NOT LESS THAN 22"X30" SHALL BE PROVIDED TO ANY ATTIC AREA HAVING A CLEAR HEIGHT OF OVER 30". SEE FLOOR PLAN FOR LOCATION.

7. ALL SHOWER COMPARTMENTS, REGARDLESS OF SHAPE, SHALL HAVE A MINIMUM FINISHED INTERIOR OF ONE THOUSAND TWENTY-FOUR (1024) SQUARE INCHES AND SHALL ALSO BE CAPABLE OF ENCOMPASSING A THIRTY (30) INCH CIRCLE. THE MINIMUM REQUIRED AREA & DIMENSIONS SHALL BE MEASURED AT A HEIGHT EQUAL TO THE TOP OF THE THRESHOLD AND AT A POINT TANGENT TO IT'S CENTERLINE. THE MINIMUM AREA & DIMENSIONS SHALL BE MAINTAINED TO A POINT SEVENTY (70) INCHES ABOVE THE SHOWER DRAIN OUTLET WITH NO PROTRUSIONS OTHER THAN THE FIXTURE VALVE OR VALVES, SHOWER HEAD AND SAFETY GRAB BARS OR RAILS.

8. PROVIDE APPROVED STREET ADDRESS NUMBER TO BE VISIBLE FROM STREET AS REQUIRED PER UBC SECTION 502.

9. PROVIDE SMOKE DETECTORS ON EACH LEVEL AS REQUIRED PER SEC 310.9.1 SMOKE DETECTORS IN NEW CONSTRUCTION SHALL BE HARD WIRED TO 110V (LOCAL LIGHTING CIRCUIT) WITH A BATTERY BACKUP AND SHALL BE INTERCONNECTED.

10. ALL ANGLES OTHER THAN 90 SHALL BE 45 TYP U.N.O.

11. PROVIDE OUTSIDE COMBUSTION AIR OPENINGS DIRECTLY INTO THE FIREPLACE FIREBOX TO COMPLY WITH CEC REGULATIONS 2-5352(D)5.

- 12. FIRESTOPS SHALL BE PROVIDED AROUND THE CHIMNEY OPENINGS AT THE CEILING AND THE FLOOR LEVELS WITH NON-COMBUSTIBLE MATERIAL, PER UBC 708.2.1.
- 13. PROVIDE 5/8" TYPE 'X' GYP BRD AT GARAGE SIDE OF WALLS AND CEILING COMMON WITH LIVING SPACES TYP PER UBC 302.4 EXCEPT. 3
- 14. PER UBC 302.4 EXCEPTION 3 FOR THE SEPARATION BETWEEN GARAGE AND LIVING SPACE: A) DUCTS PENETRATING THE SEPARATION SHALL BE CONSTRUCTED OF NOT LESS THAN 26 GA GALV.
 - SHEET STEEL. FIRE DAMPERS NEED NOT BE INSTALLED IN DUCTS PASSING THROUGH THE WALL AND FLOOR OR CEILING SEPARATION.
 - B) PIPING PENETRATIONS SHALL BE METAL INCLUDING PIPES EXPOSED IN THE GARAGE.

GENERAL NOTES

A. FOR PLATE HEIGHTS SEE ARCHITECTURAL SECTIONS. B. ALL WINDOW HEADER HEIGHTS SHALL BE 8'-0" A.F.F., U.N.O. -REFER TO EXTERIOR ELEVATIONS.

C. ALL EXTERIOR WALLS SHALL BE 2X6'S AT 16" O.C., U.O.N.-SEE LEGEND FOR WALL TYPES.

D. ALL INTERIOR WALLS SHALL BE 2X4'S AT 16" O.C., U.O.N.-SEE LEGEND FOR WALL TYPES.

E. PROVIDE TYPICAL INSULATION @ CONDITIONED SPACES ONLY U.O.N. - REFER TO TITLE 24 FOR SPECIFIC INFORMATION. WALLS: R-13 INSULATION

ATTIC: R-30 @ VAULTED CLG./R-30 @ FLAT CLG. UNDERFLOOR: R-19 INSULATION INCL. GARAGE CEILING.

F. USE 1/2" GYPSUM BOARD THROUGH-OUT WHERE STUD SPACING IS 16" O.C., U.O.N. USE 5/8" TYPE "X" GYPSUM BOARD UNDERNEATH ALL STAIRS AND AT GARAGE CEILINGS, WALLS, BEAMS AND COLUMNS. SEE FLOOR PLAN FOR ADDITIONAL INFORMATION.

G. MAXIMUM CHANGE OF ELEVATION AT EXTERIOR DOORS SHALL NOT EXCEED 8" MAX. FOR IN-SWING DOORS AND 1" MAX. FOR OUT-SWING DOORS.

H. EACH ZONE MUST BE SERVED BY A RETURN AIR REGISTER LOCATED WITHIN THAT ZONE.

LEGEND 8" & 12" THICK RETAINING WALLS EXTERIOR 2X6 WALL INTERIOR 2X4 WALL - SECTION NO. SECTION CUT REFERENCE A16 SHEET NO. — DETAIL NO. DETAIL CUT REFERENCE —SHEET NO. -ELEVATION DIRECTION INTERIOR ELEVATION A 9 C REFERENCE - ROOM ELEVATION NO. FEET 1⁰0⁰ DOORS WINDOWS 2436 INCHES

1. ALL DIMENSIONS ARE FROM FACE OF STUD TO FACE OF STUD


the Designer

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Date: Sep 22, 2003 le name: 9944-#2 Men A.mcd

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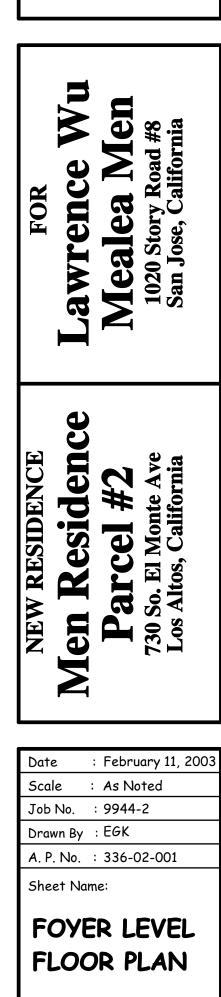


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URBAN **DESIGN &** PLANNING


405 Alberto Way, Suite C Los Gatos, CA 95032-5406 (408) 358-3707 Fax (408) 356-1969 E-Mail Pardesgr@AOL.com MEMBER A.I.B.D., B.I.A.

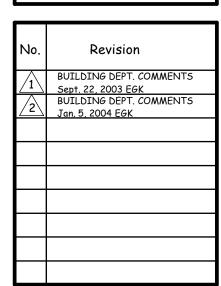
Armen Shamamian Professional Engineer



Sheet No.

A-2A

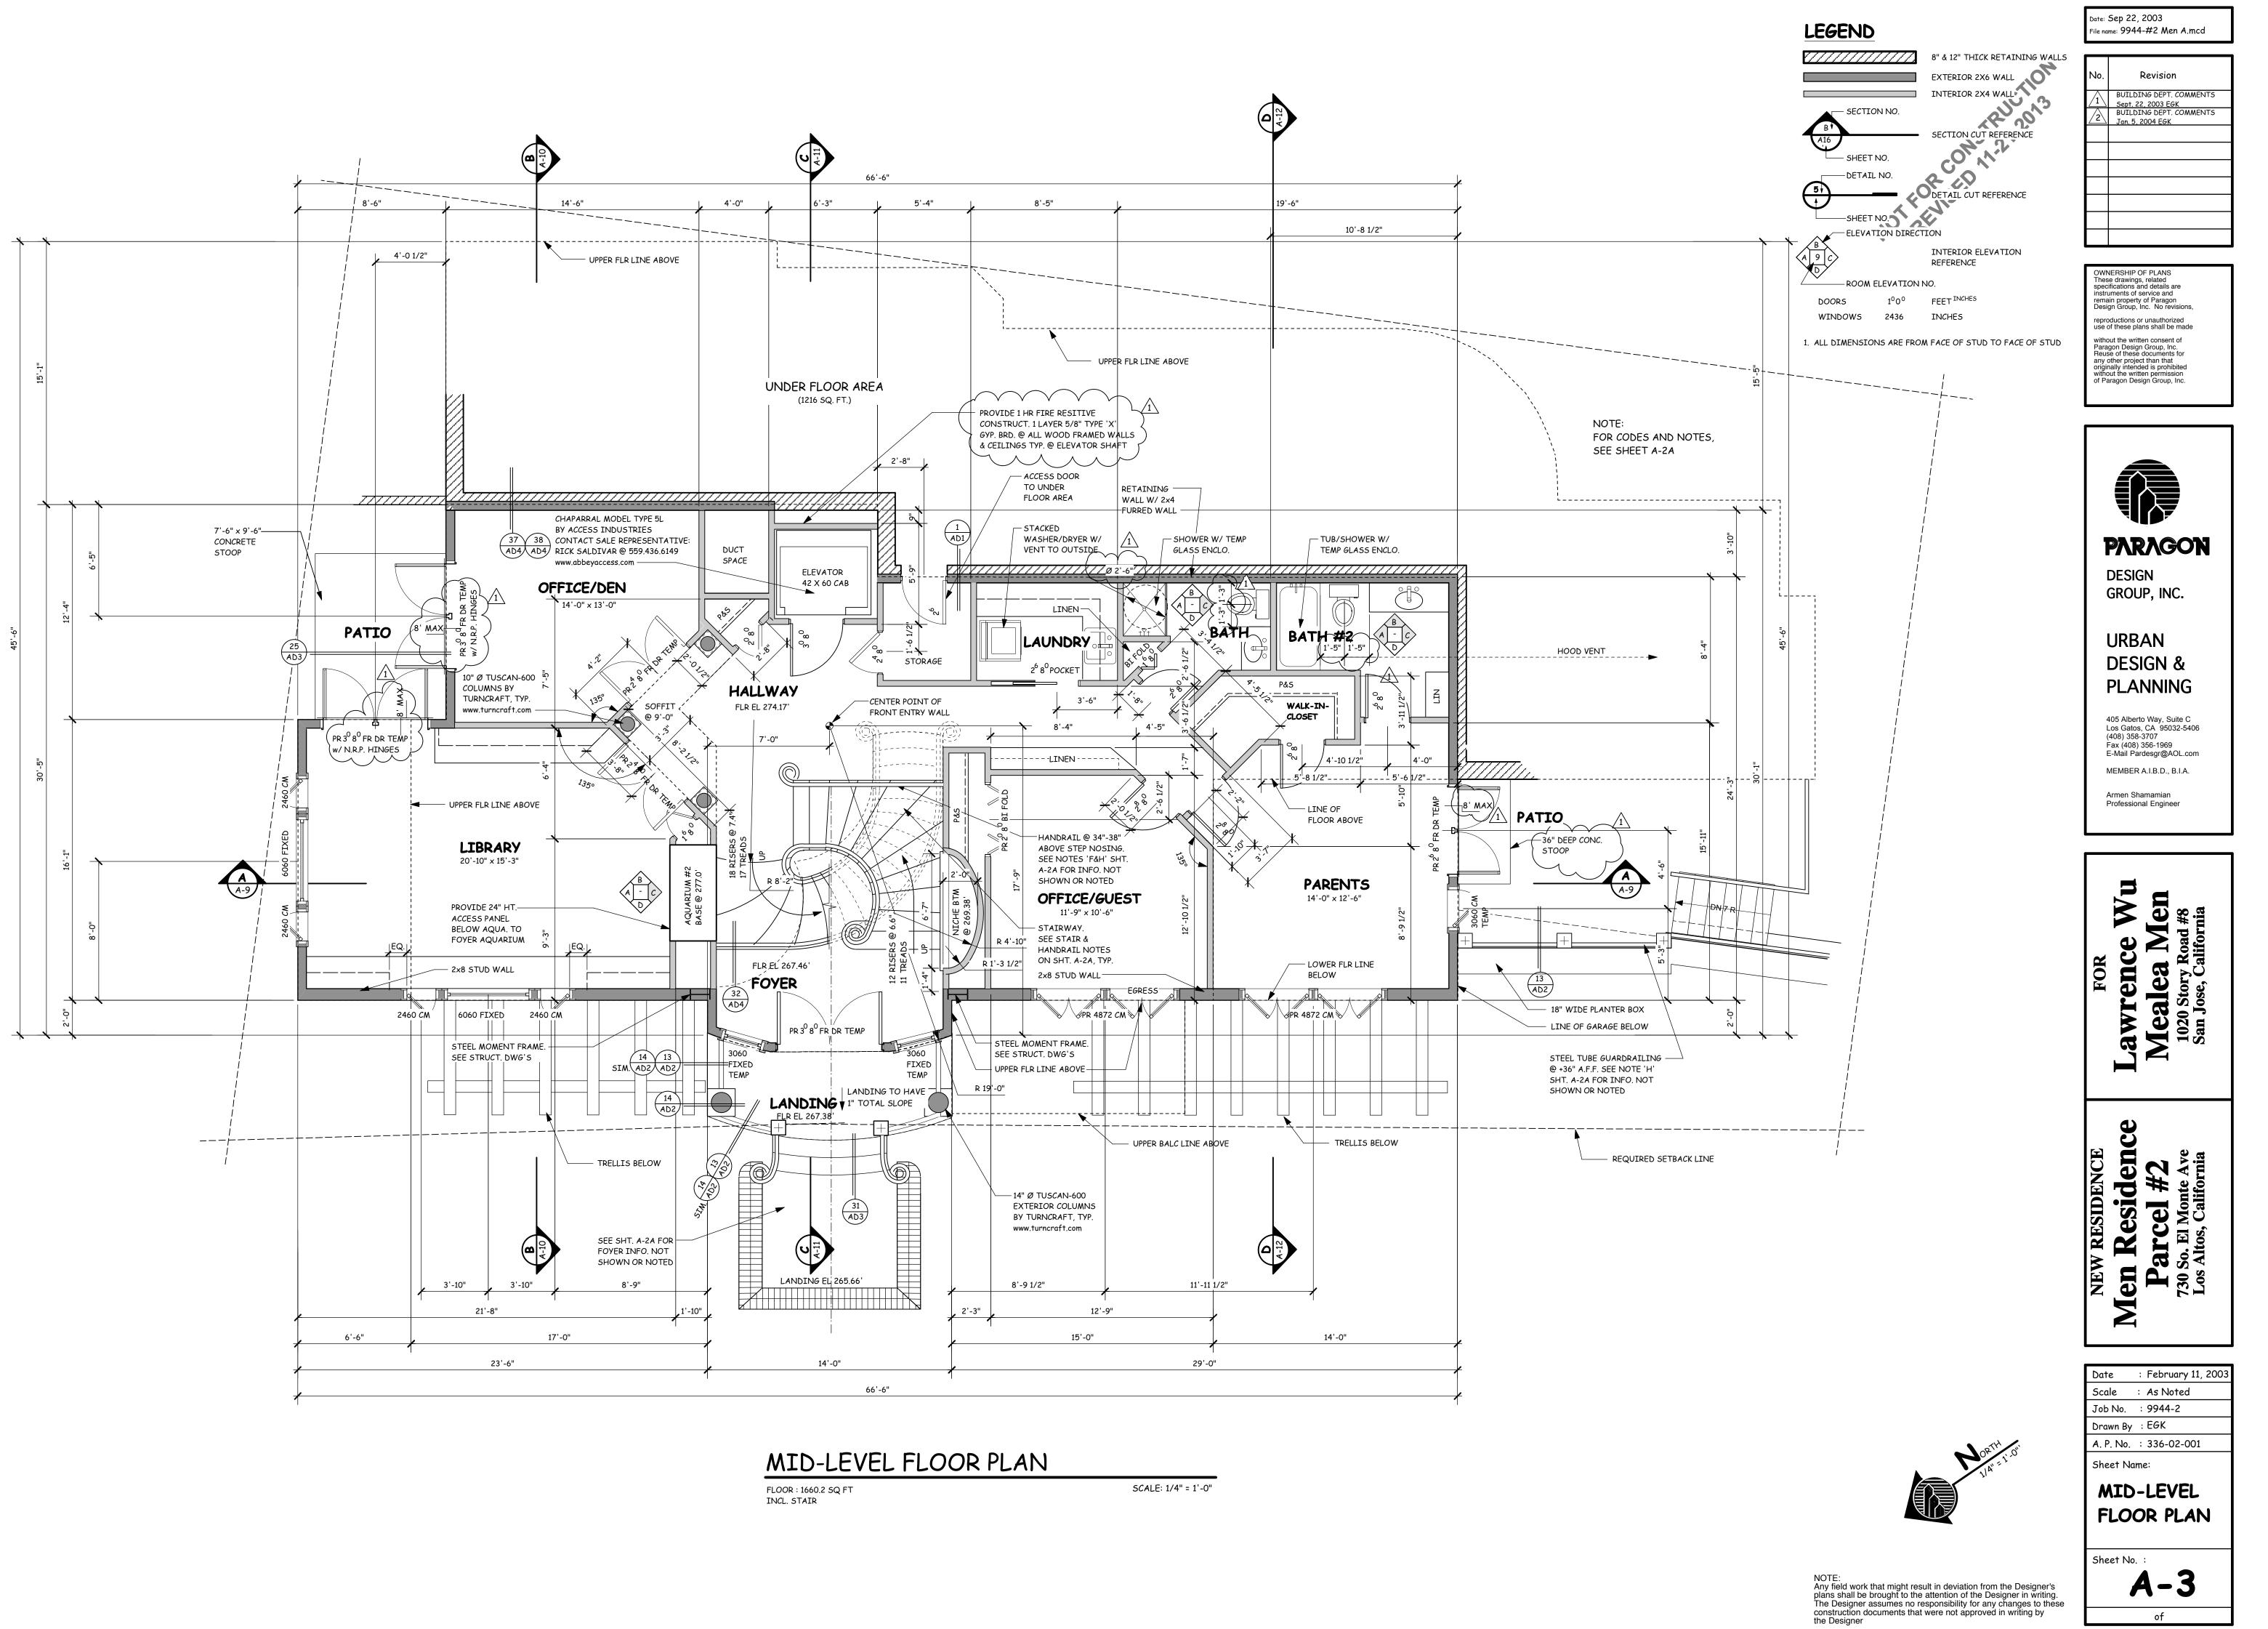

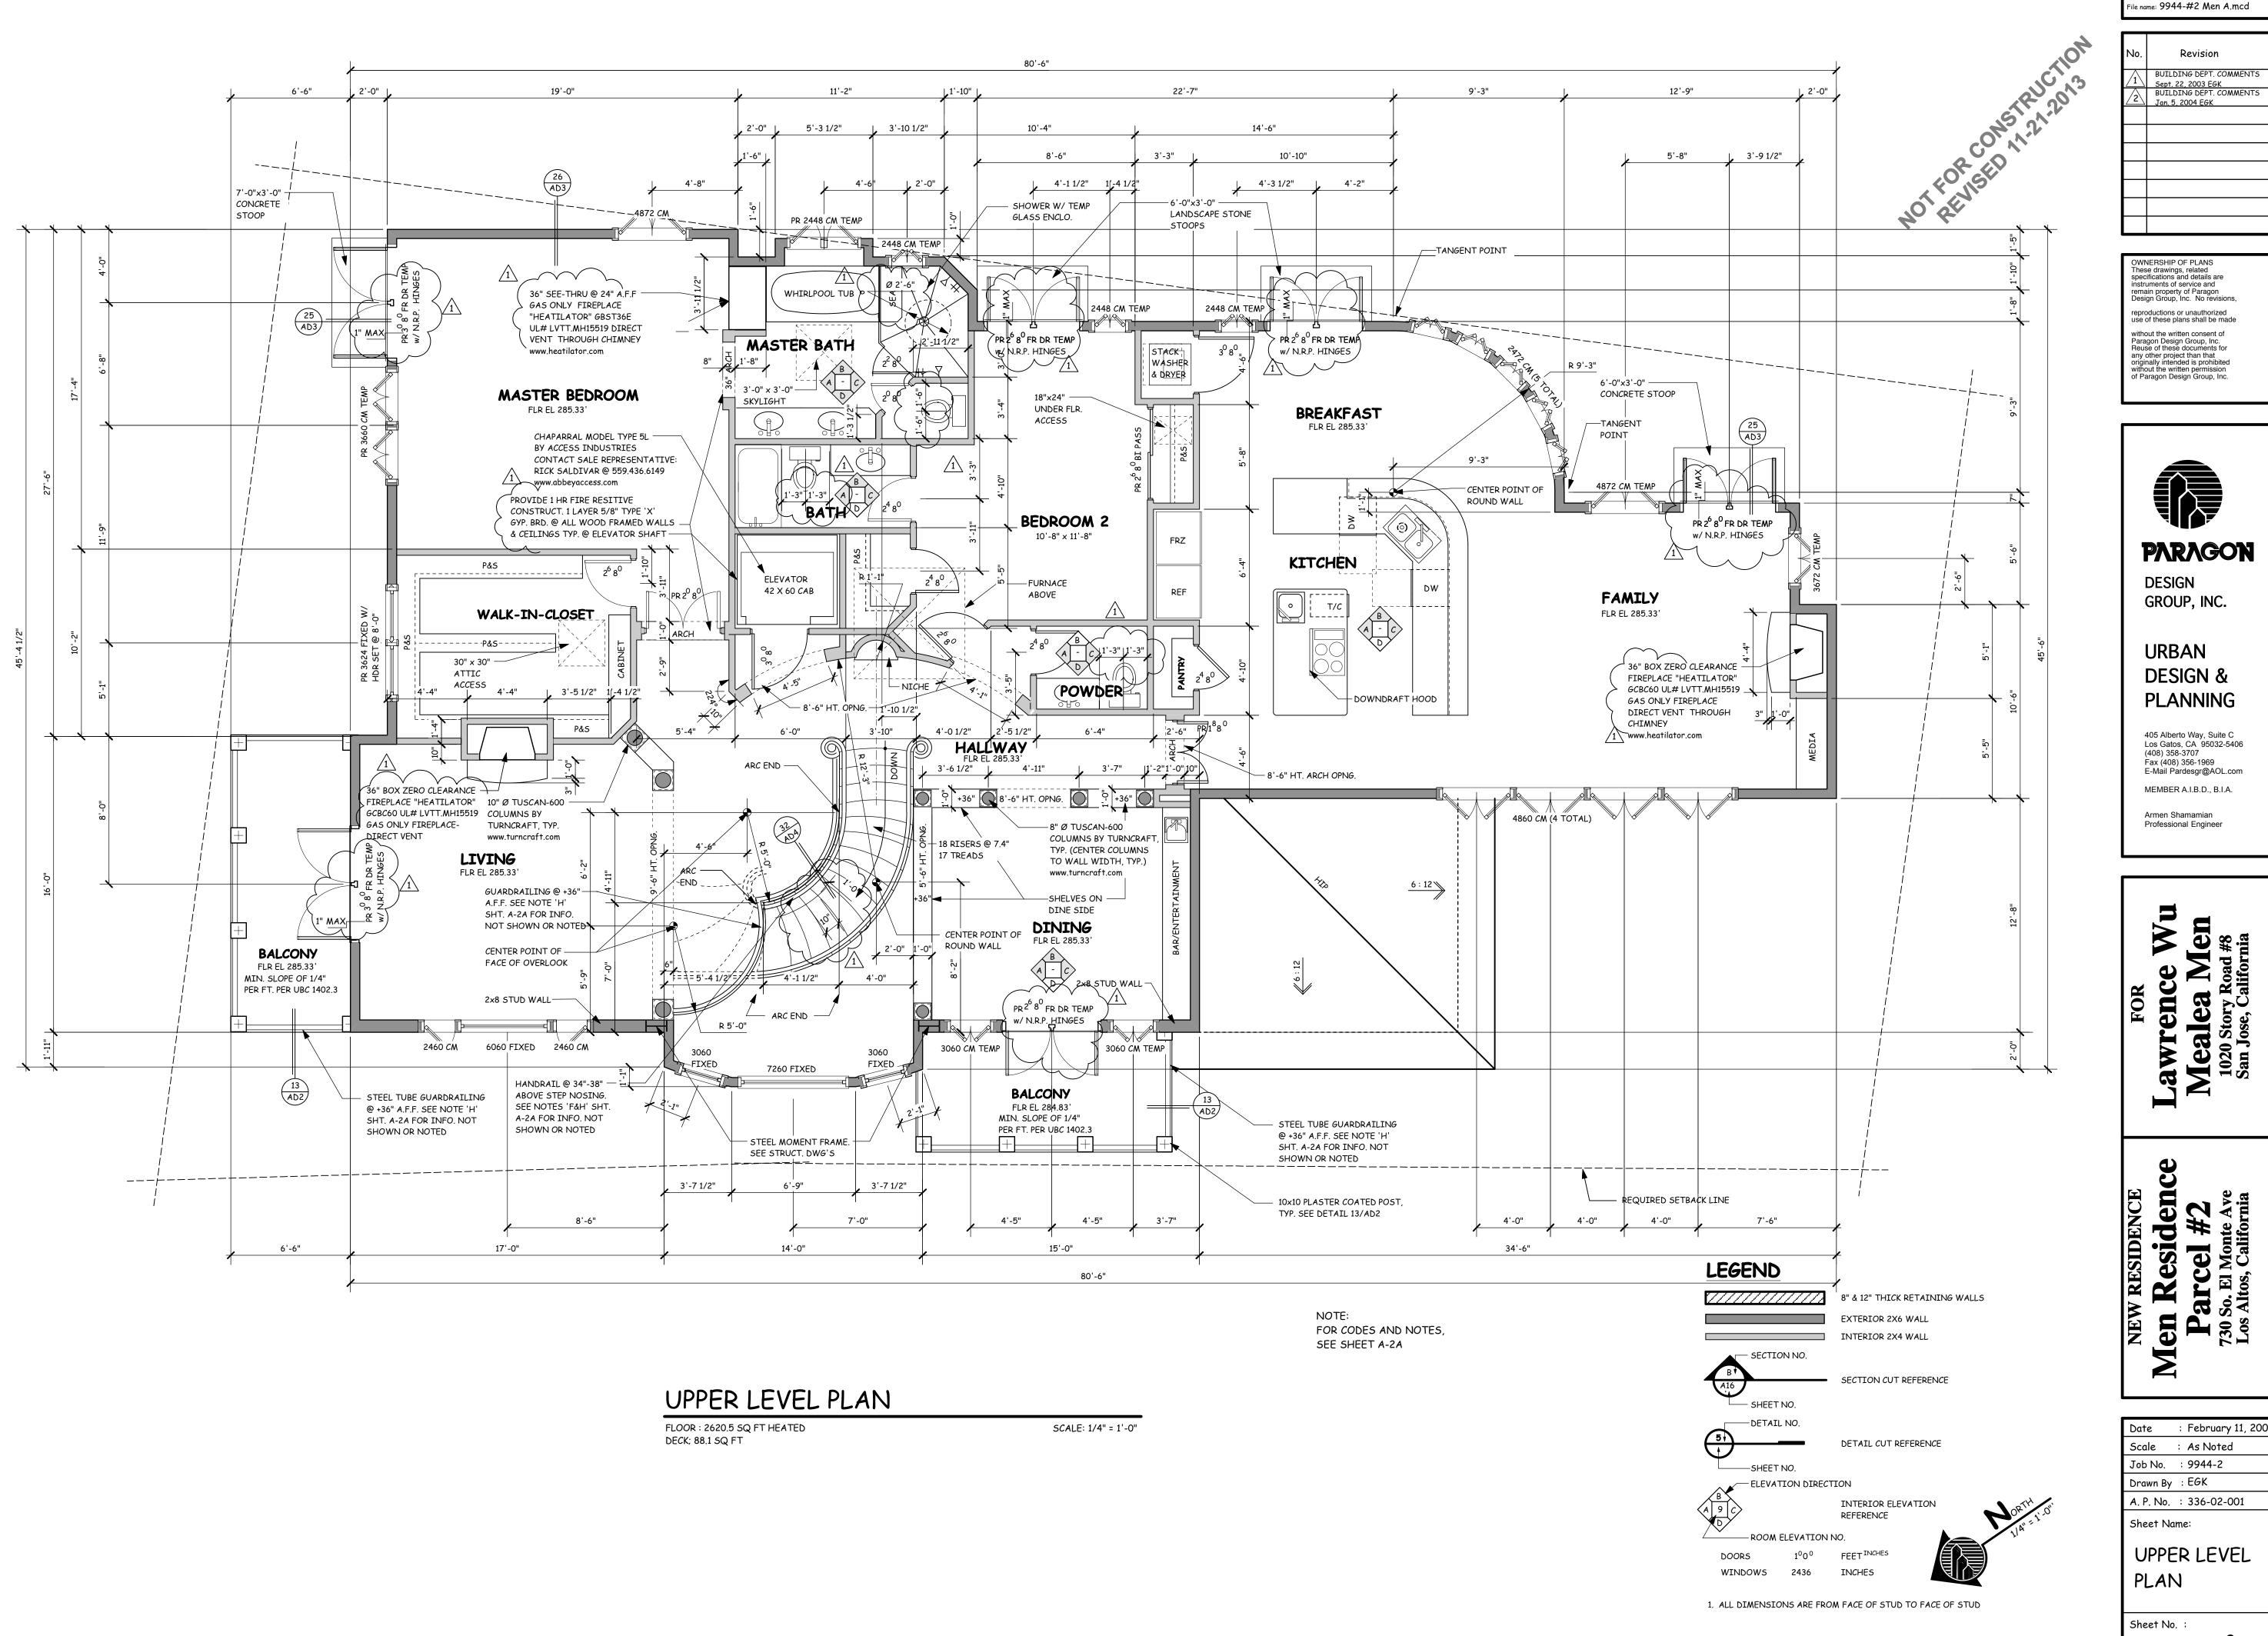


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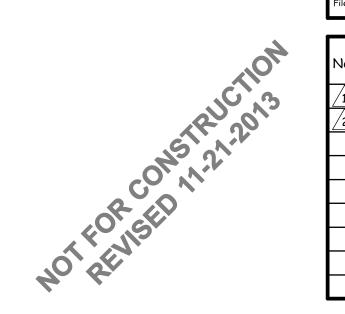
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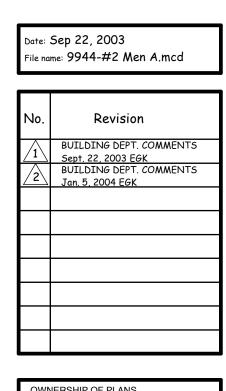




NOTE: ALL RWL TO TERMINATE AT GRADE INTO ENCLOSED PIPE SYSTEM.


SCALE: 1/4" = 1'-0"

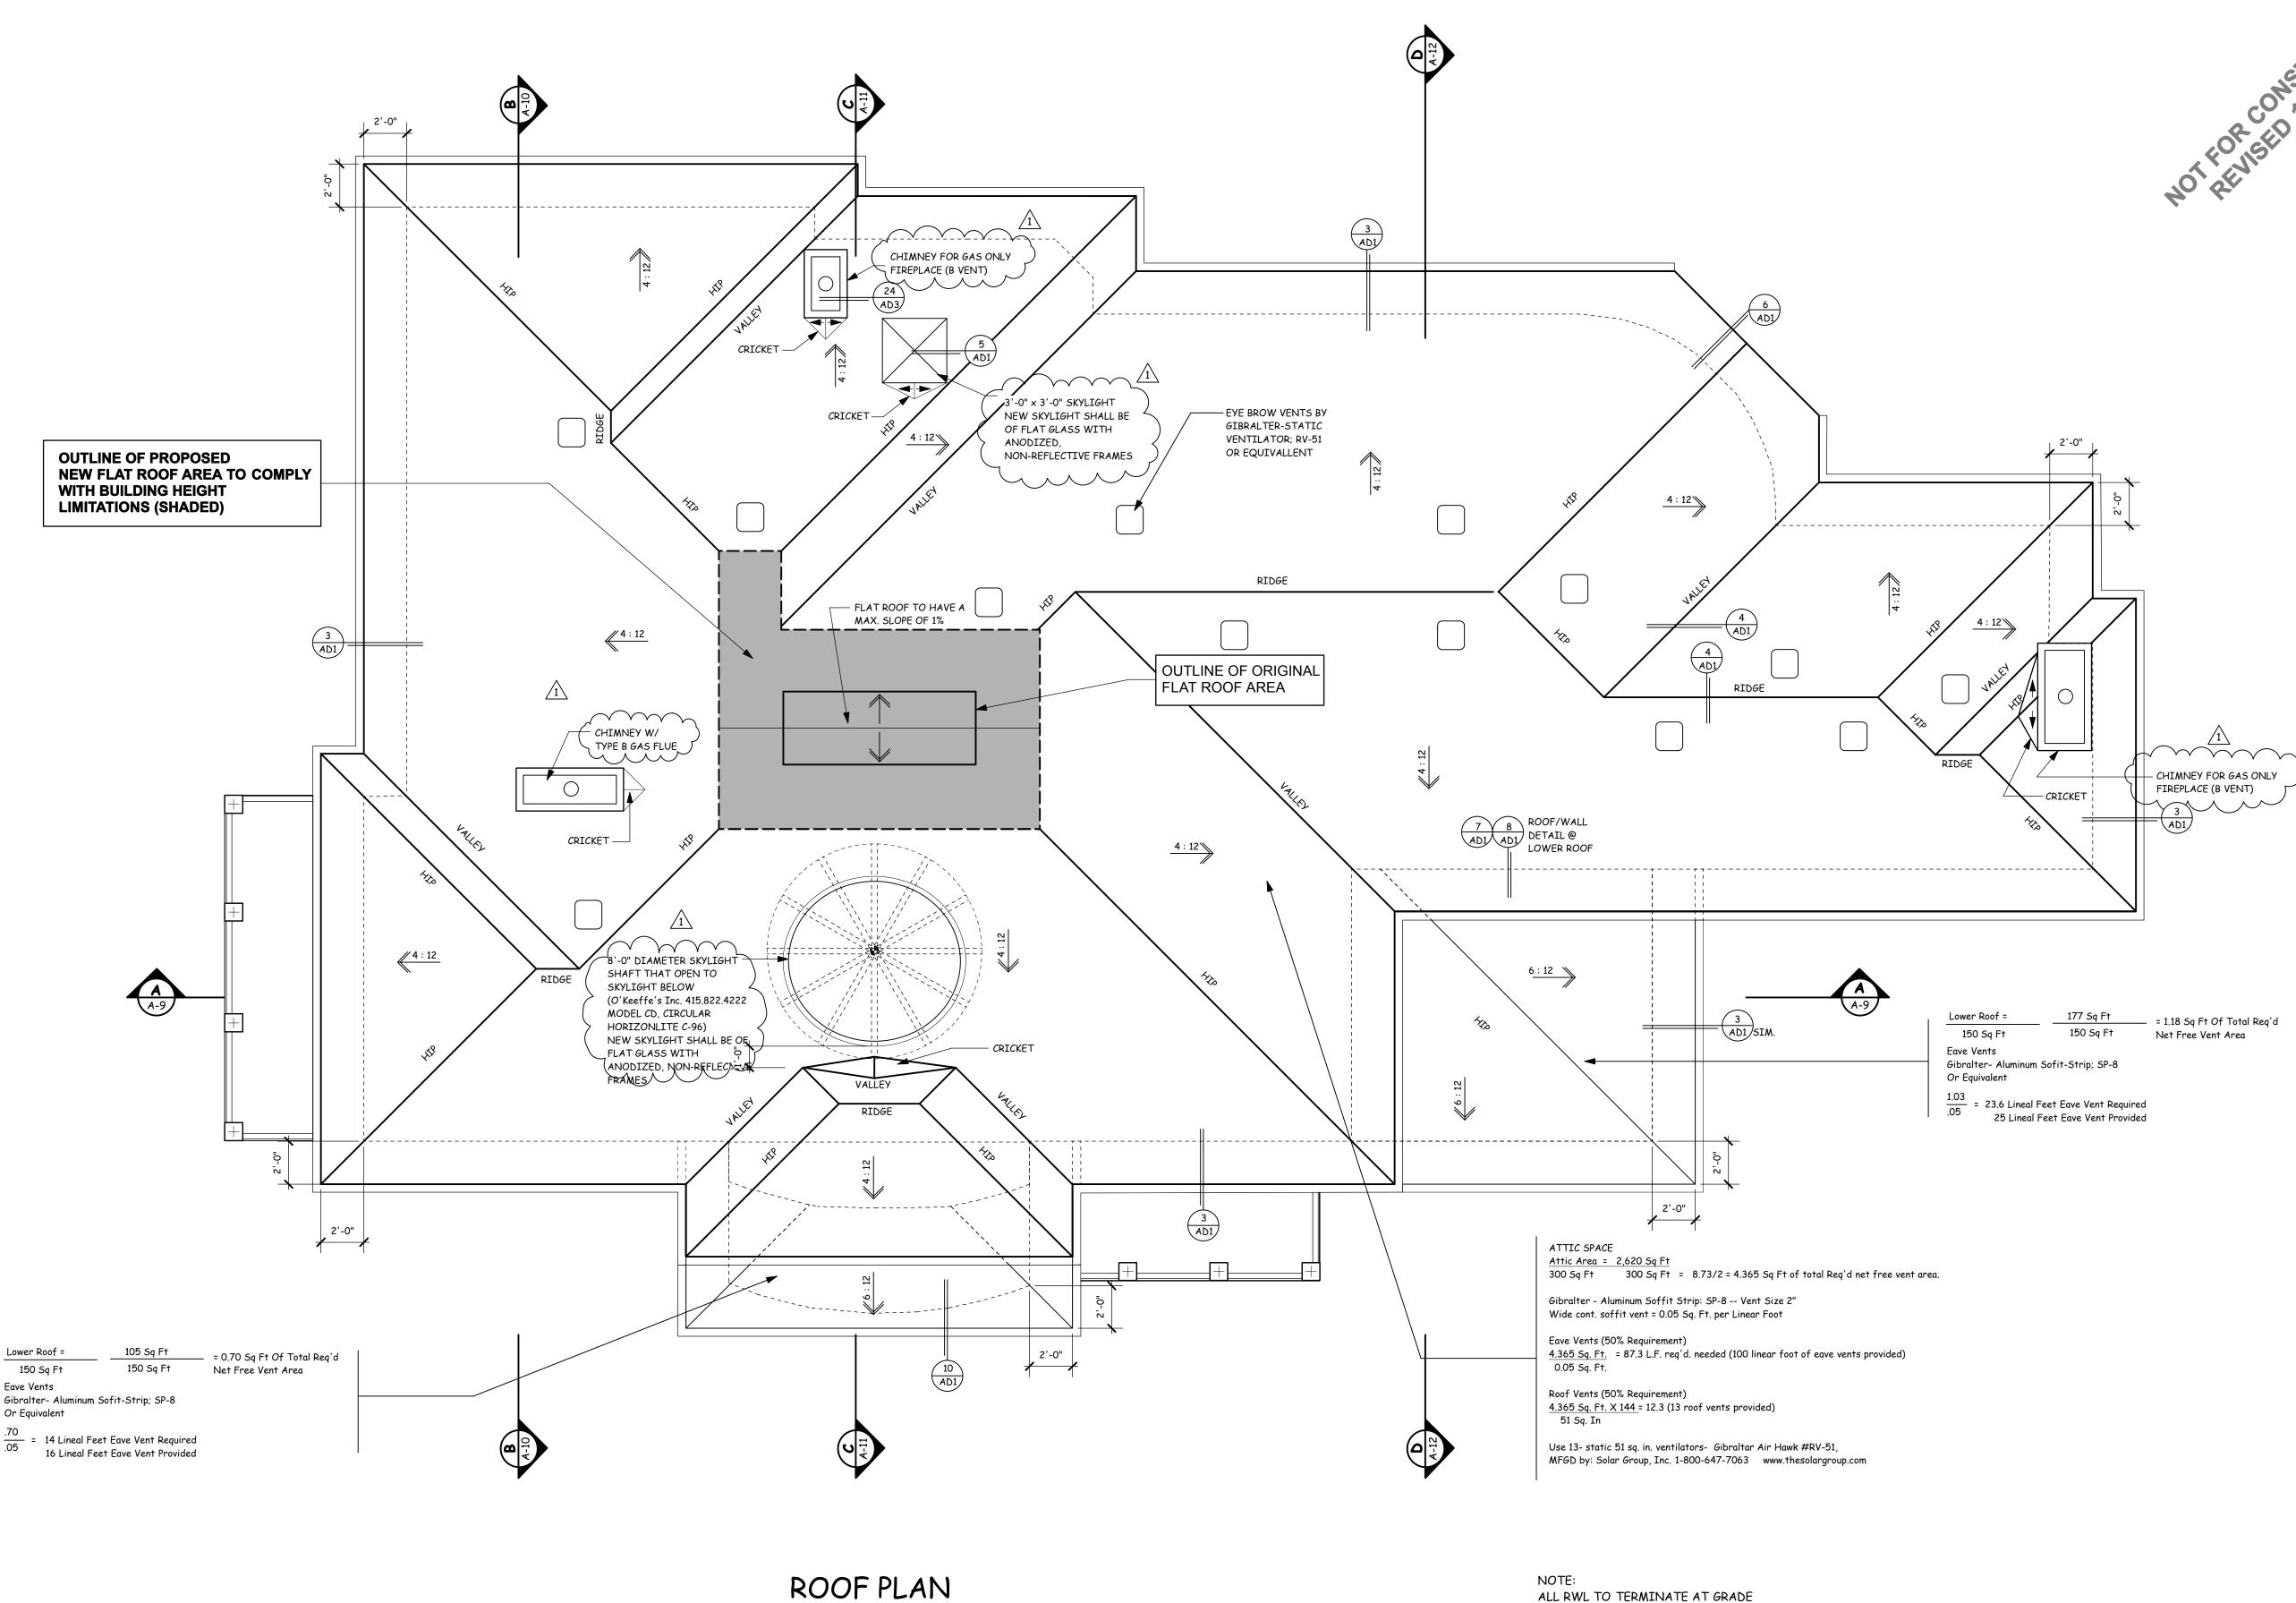




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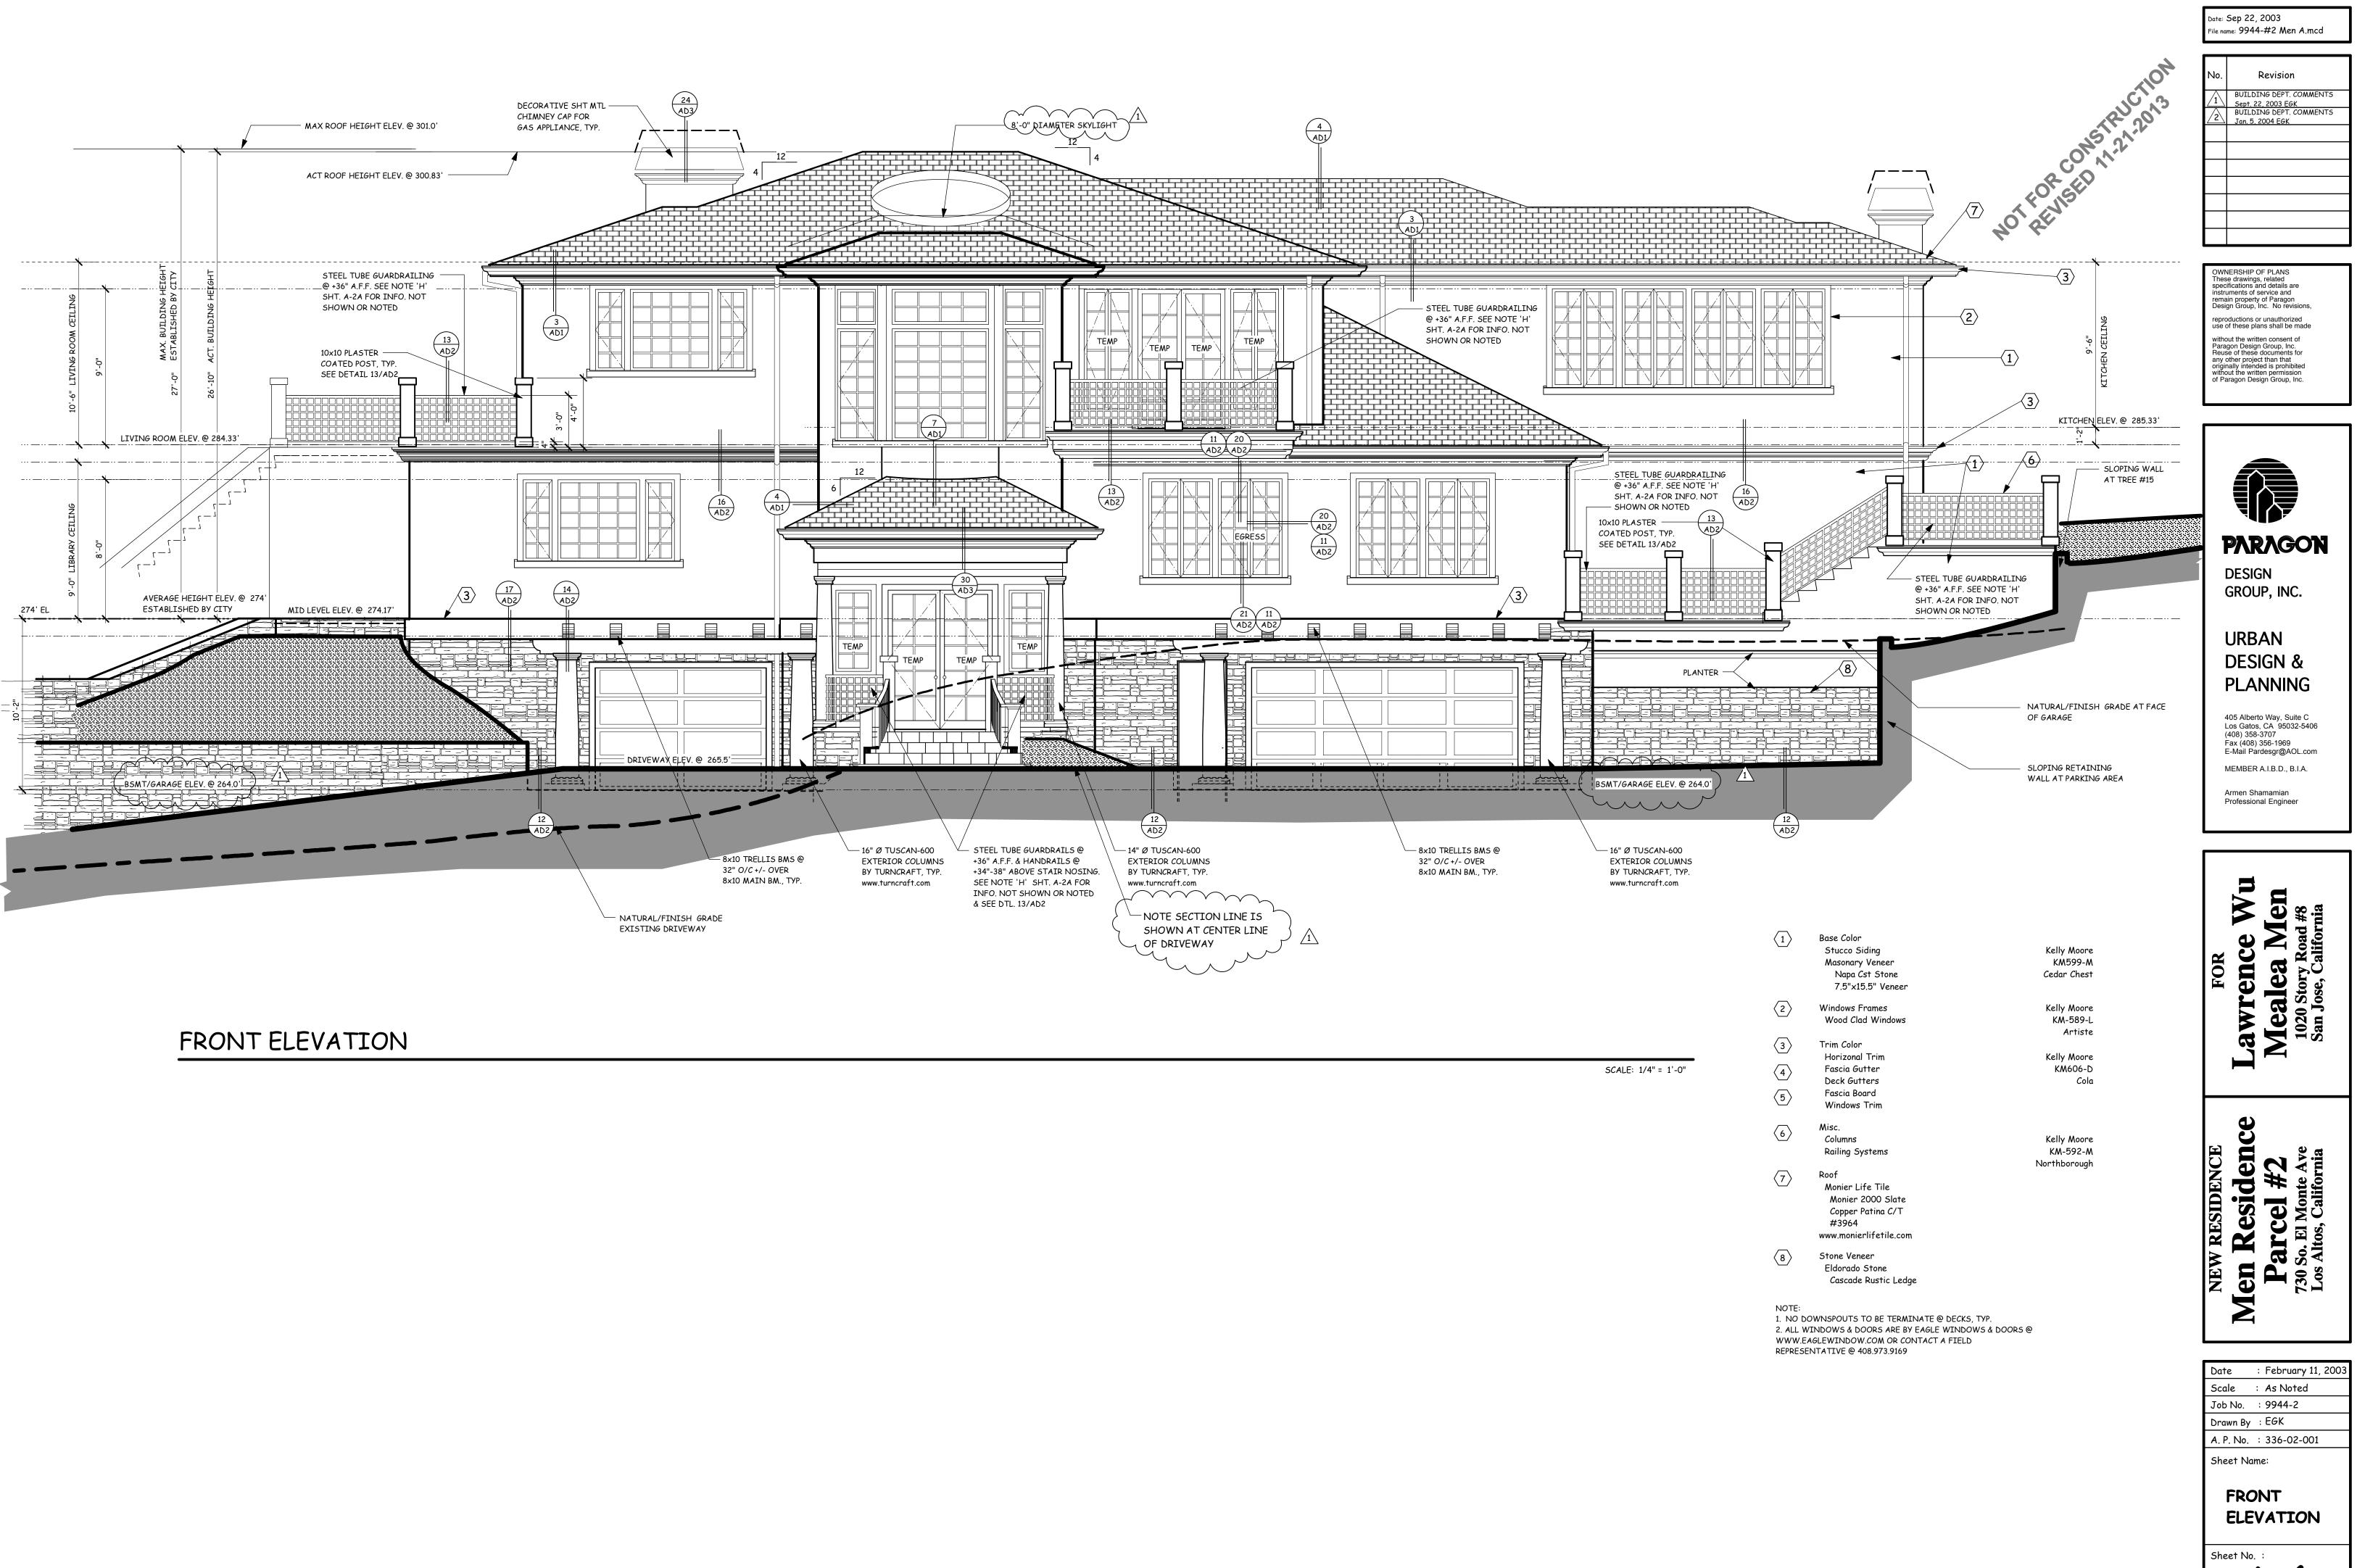




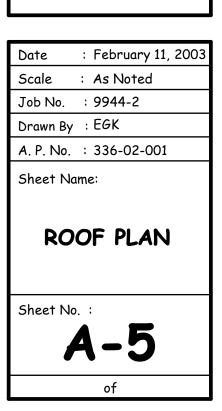

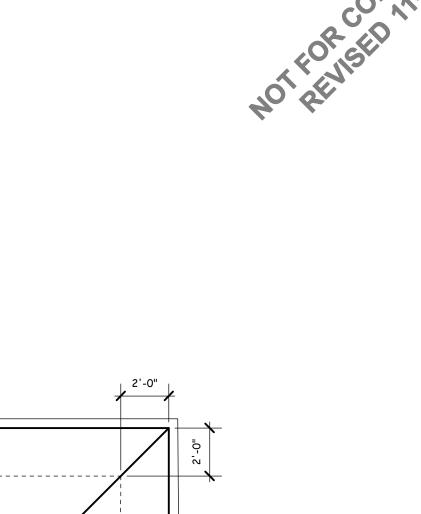


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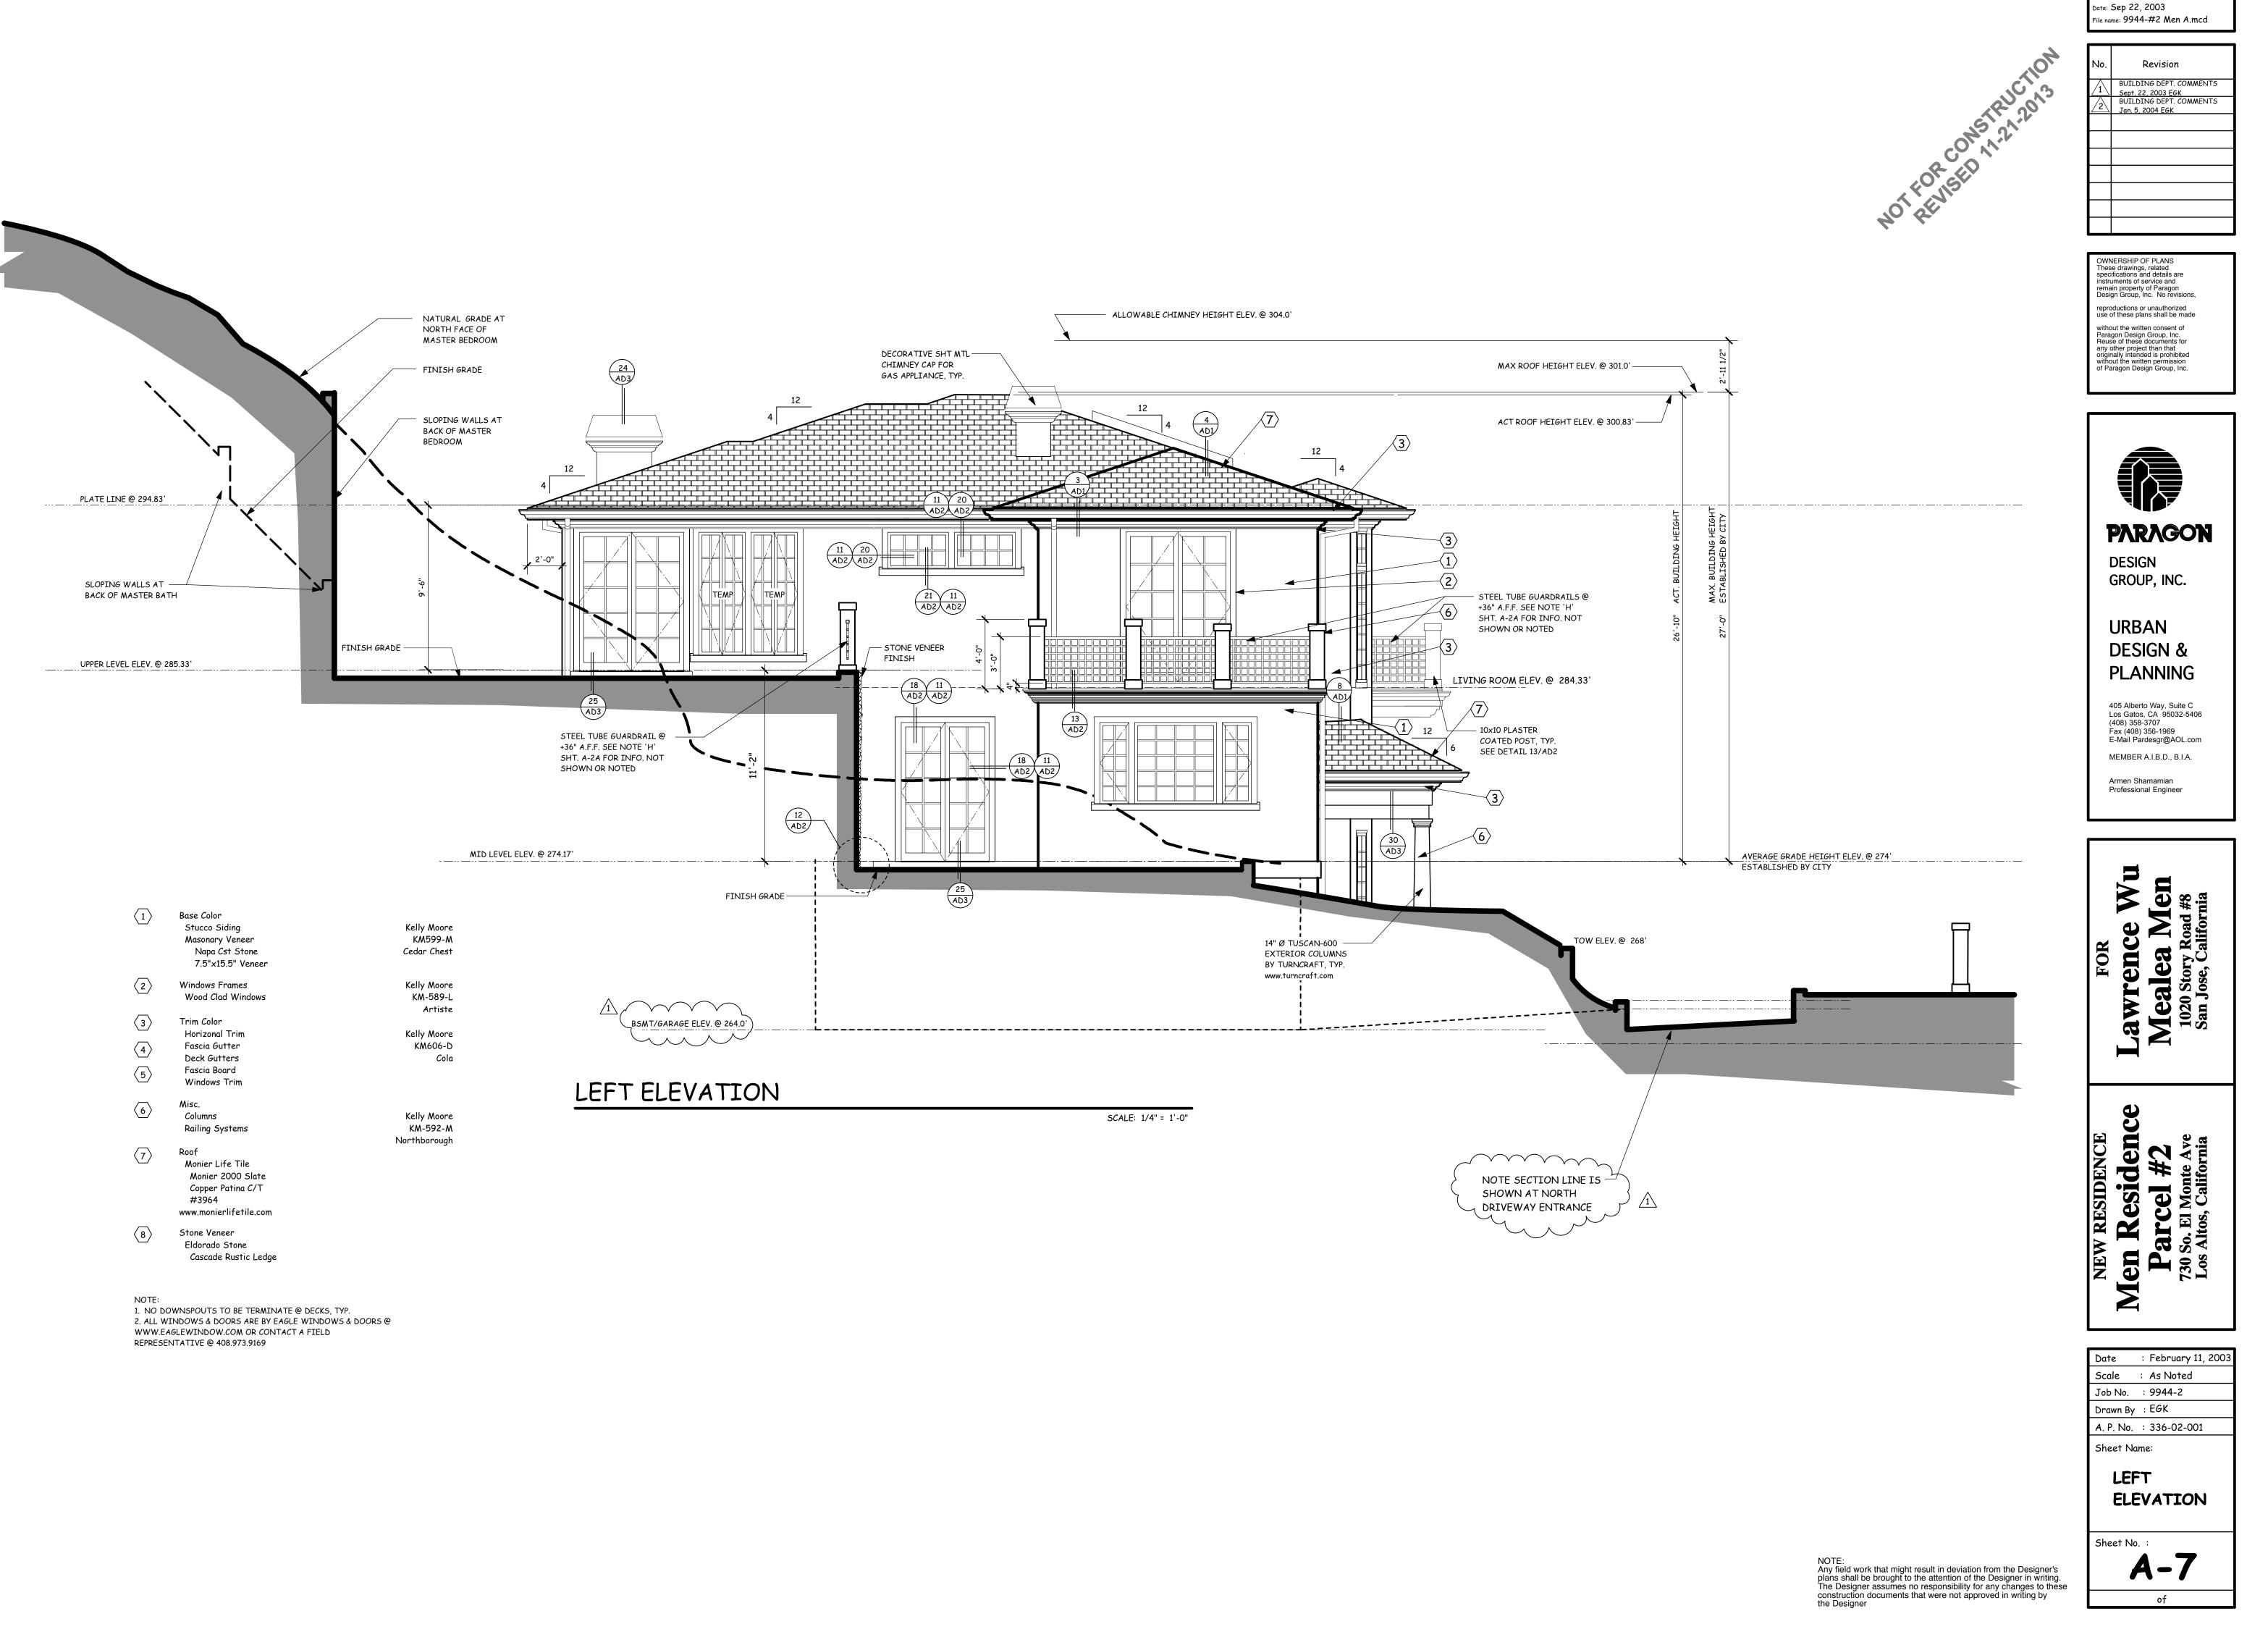
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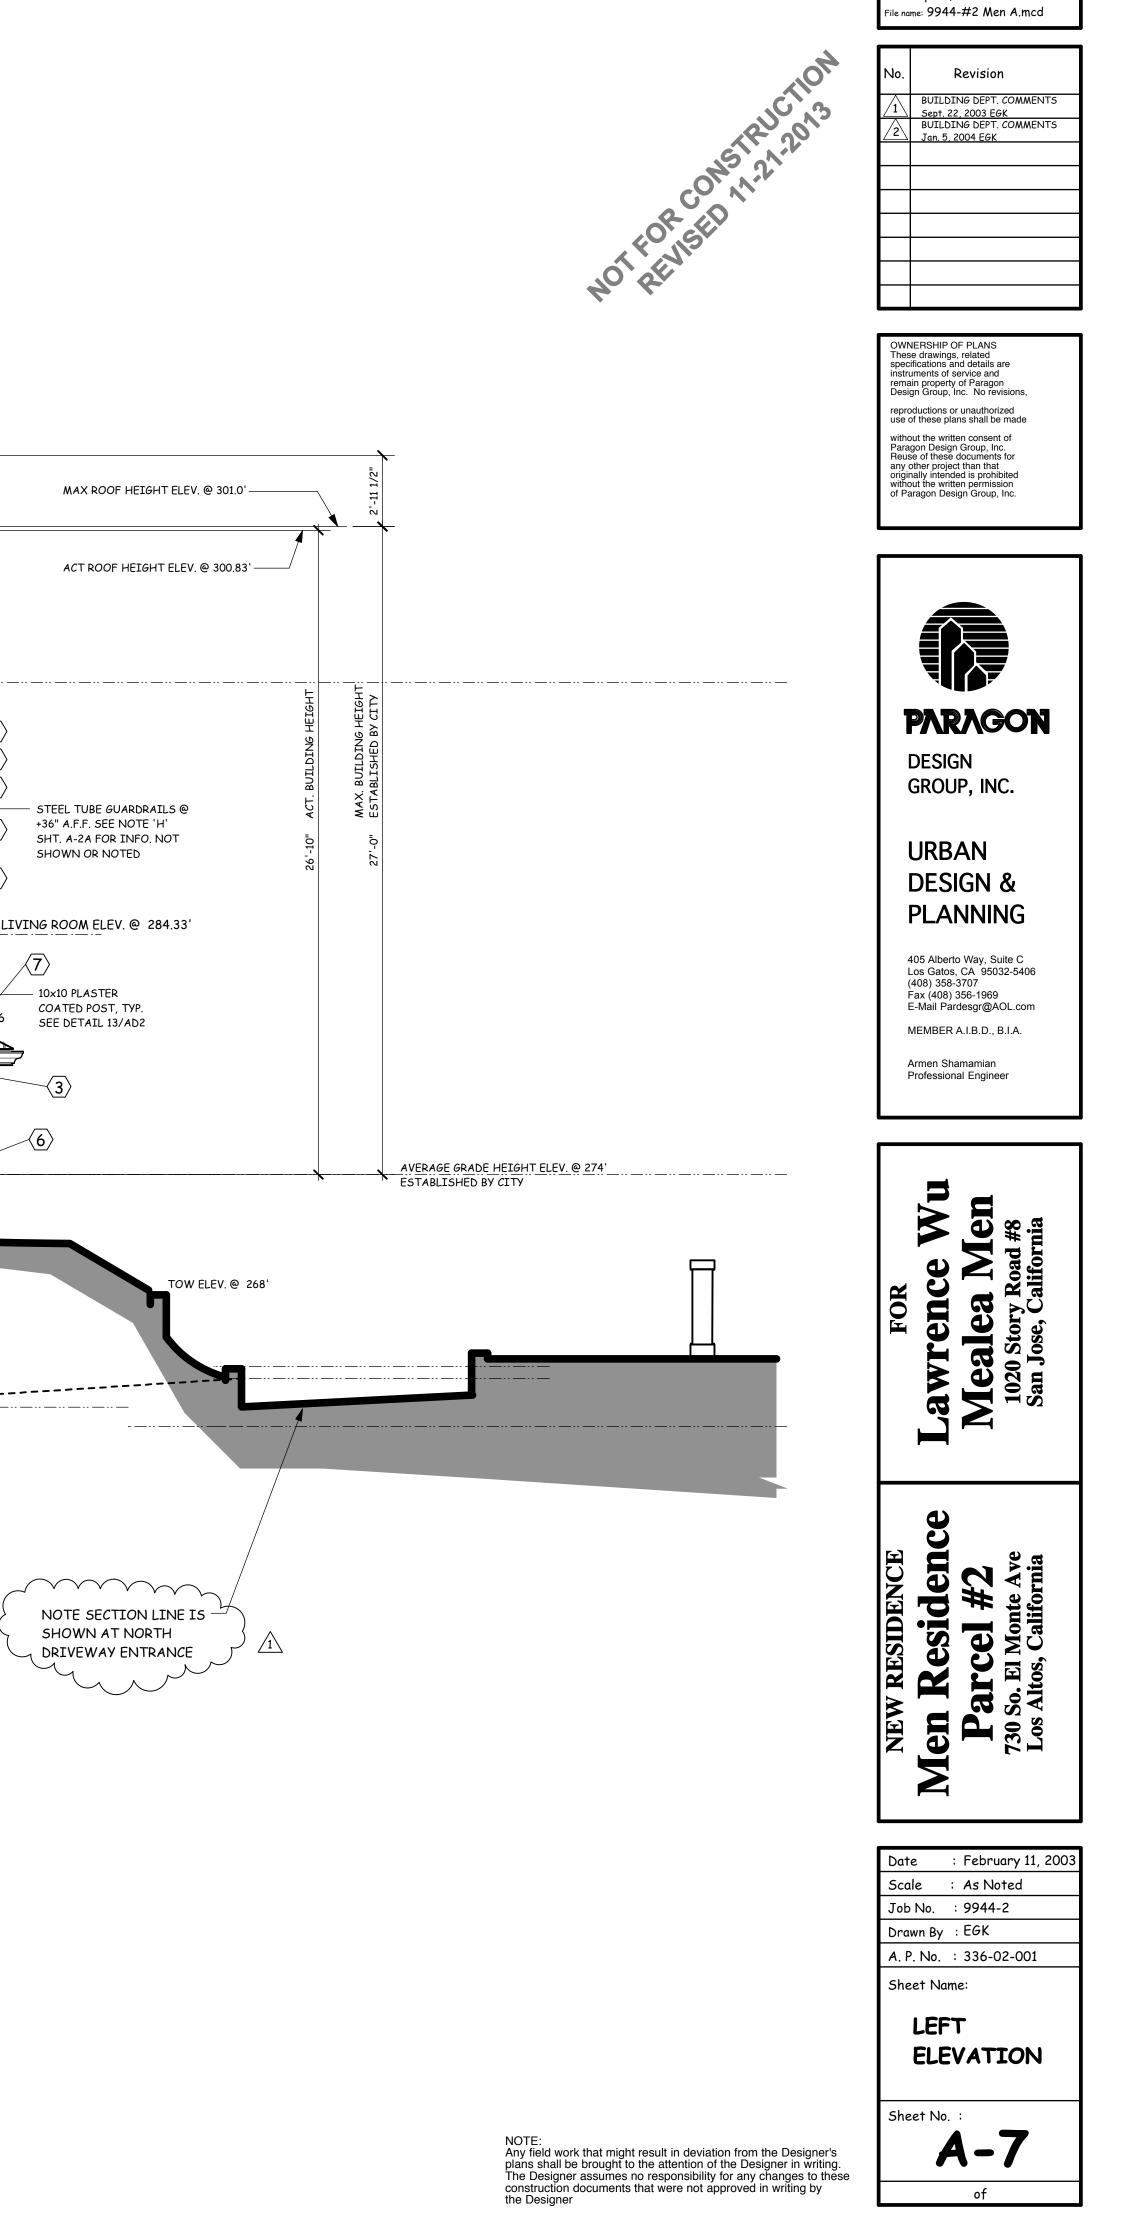
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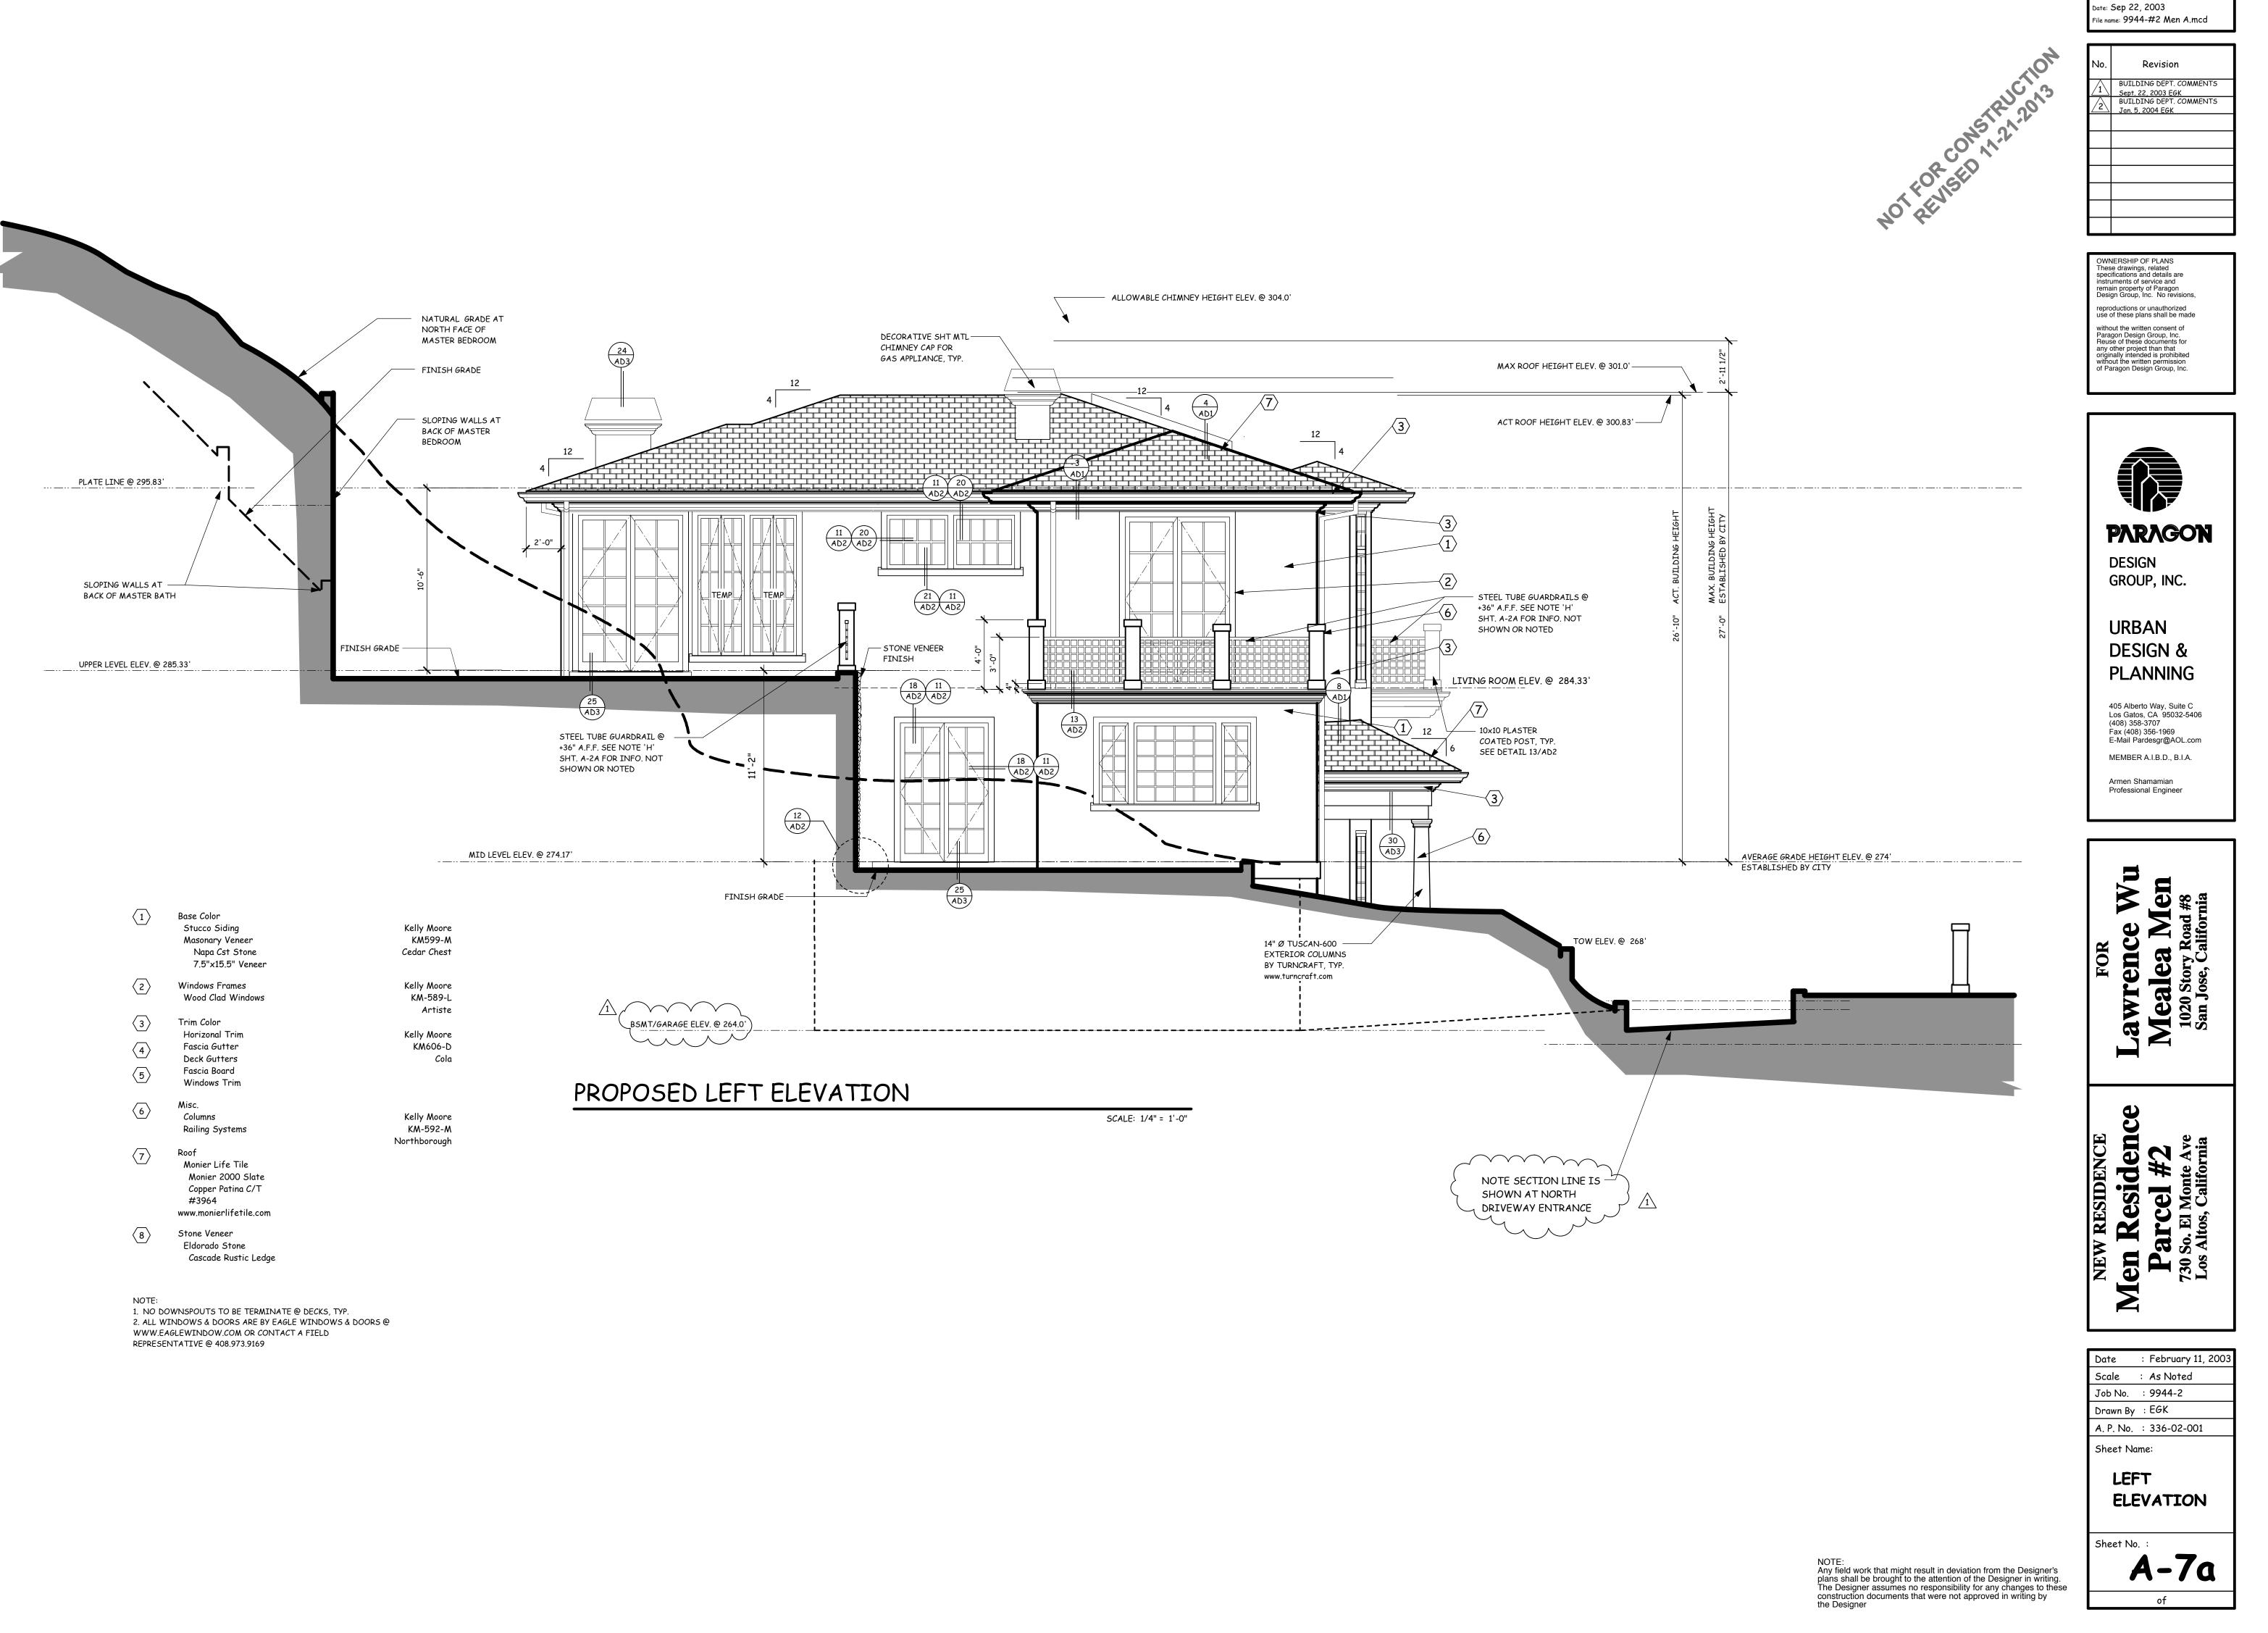


$\langle 1 \rangle$	Base Color Stucco Siding Masonary Veneer Napa Cst Stone 7.5"×15.5" Veneer	Kelly Moore KM599-M Cedar Chest
2	Windows Frames Wood Clad Windows	Kelly Moore KM-589-L Artiste
 3 4 5 	Trim Color Horizonal Trim Fascia Gutter Deck Gutters Fascia Board Windows Trim	Kelly Moore KM606-D Cola
6	Misc. Columns Railing Systems	Kelly Moore KM-592-M Northborough
(7)	Roof Monier Life Tile Monier 2000 Slate Copper Patina C/T #3964 www.monierlifetile.com	Normborougn
8	Stone Veneer Eldorado Stone Cascada Pustic Ladae	





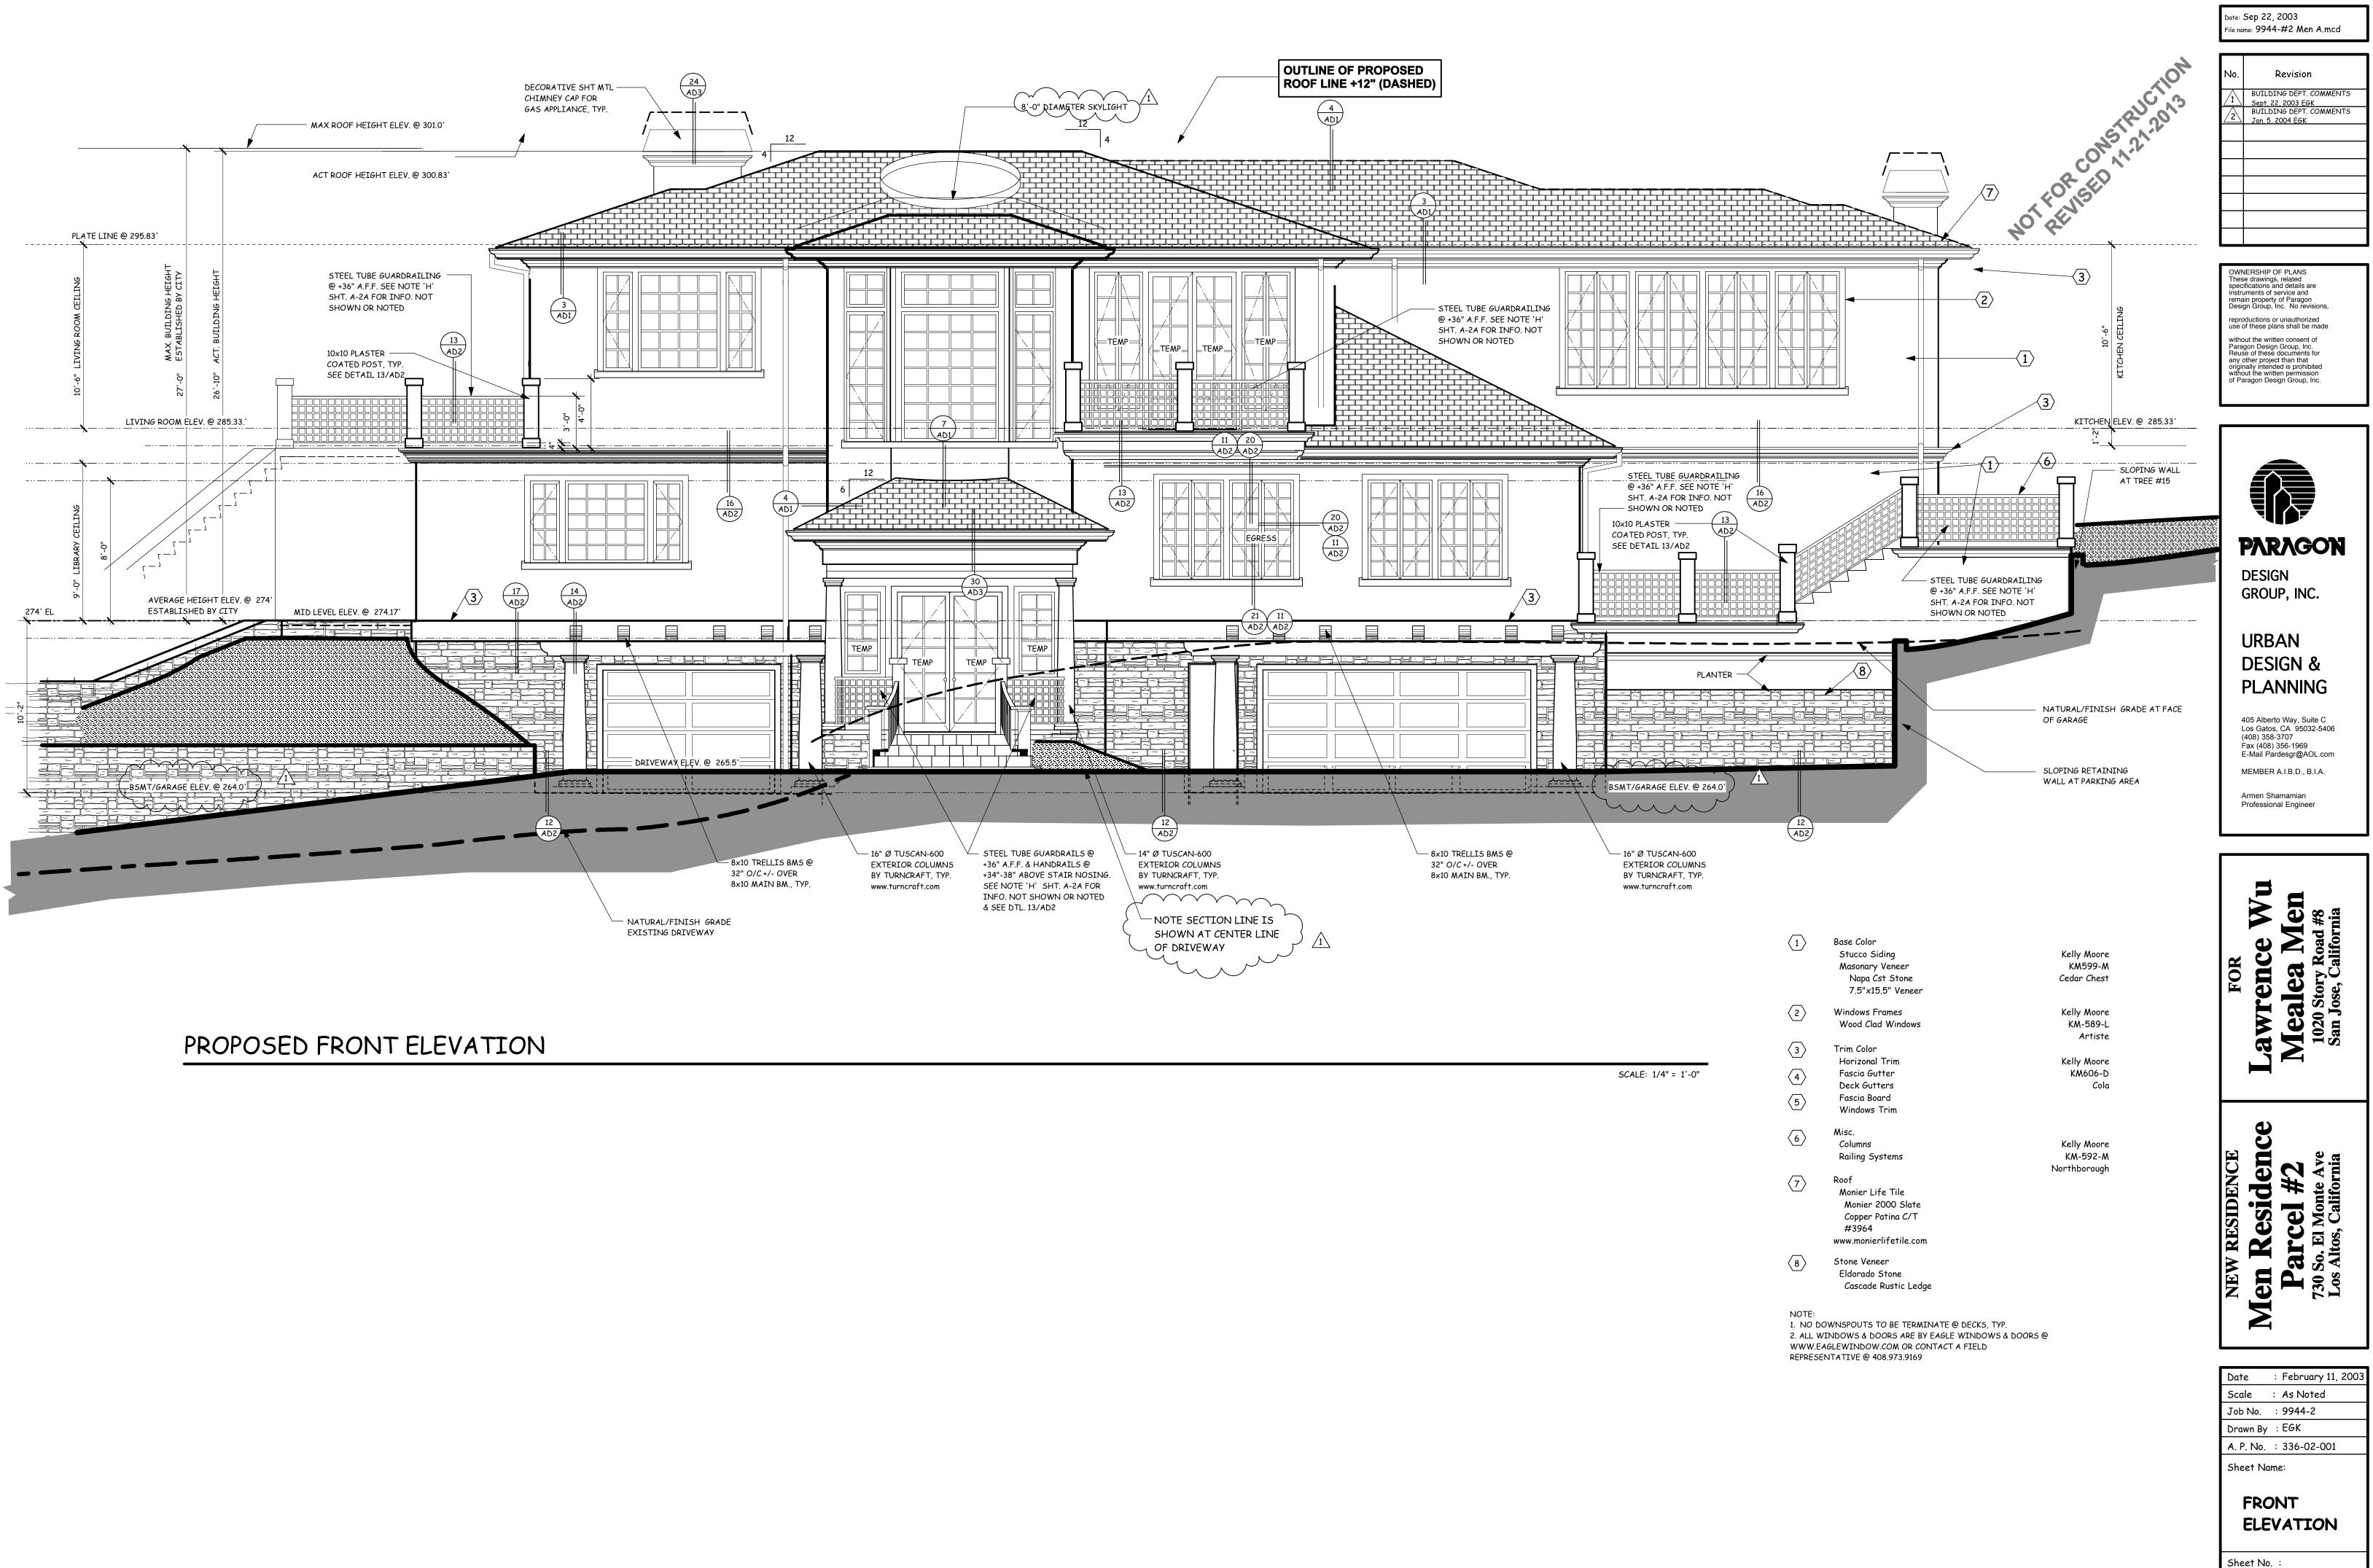





$\langle 1 \rangle$	Base Color Stucco Siding Masonary Veneer Napa Cst Stone 7.5"×15.5" Veneer	Kelly Moore KM599-M Cedar Chest
2	Windows Frames Wood Clad Windows	Kelly Moore KM-589-L Artiste
 3 4 5 	Trim Color Horizonal Trim Fascia Gutter Deck Gutters Fascia Board Windows Trim	Kelly Moore KM606-D Cola
6	Misc. Columns Railing Systems	Kelly Moore KM-592-M
(7)	Roof Monier Life Tile Monier 2000 Slate Copper Patina C/T #3964 www.monierlifetile.com	Northborough
8	Stone Veneer Eldorado Stone	



RIGHT ELEVATION

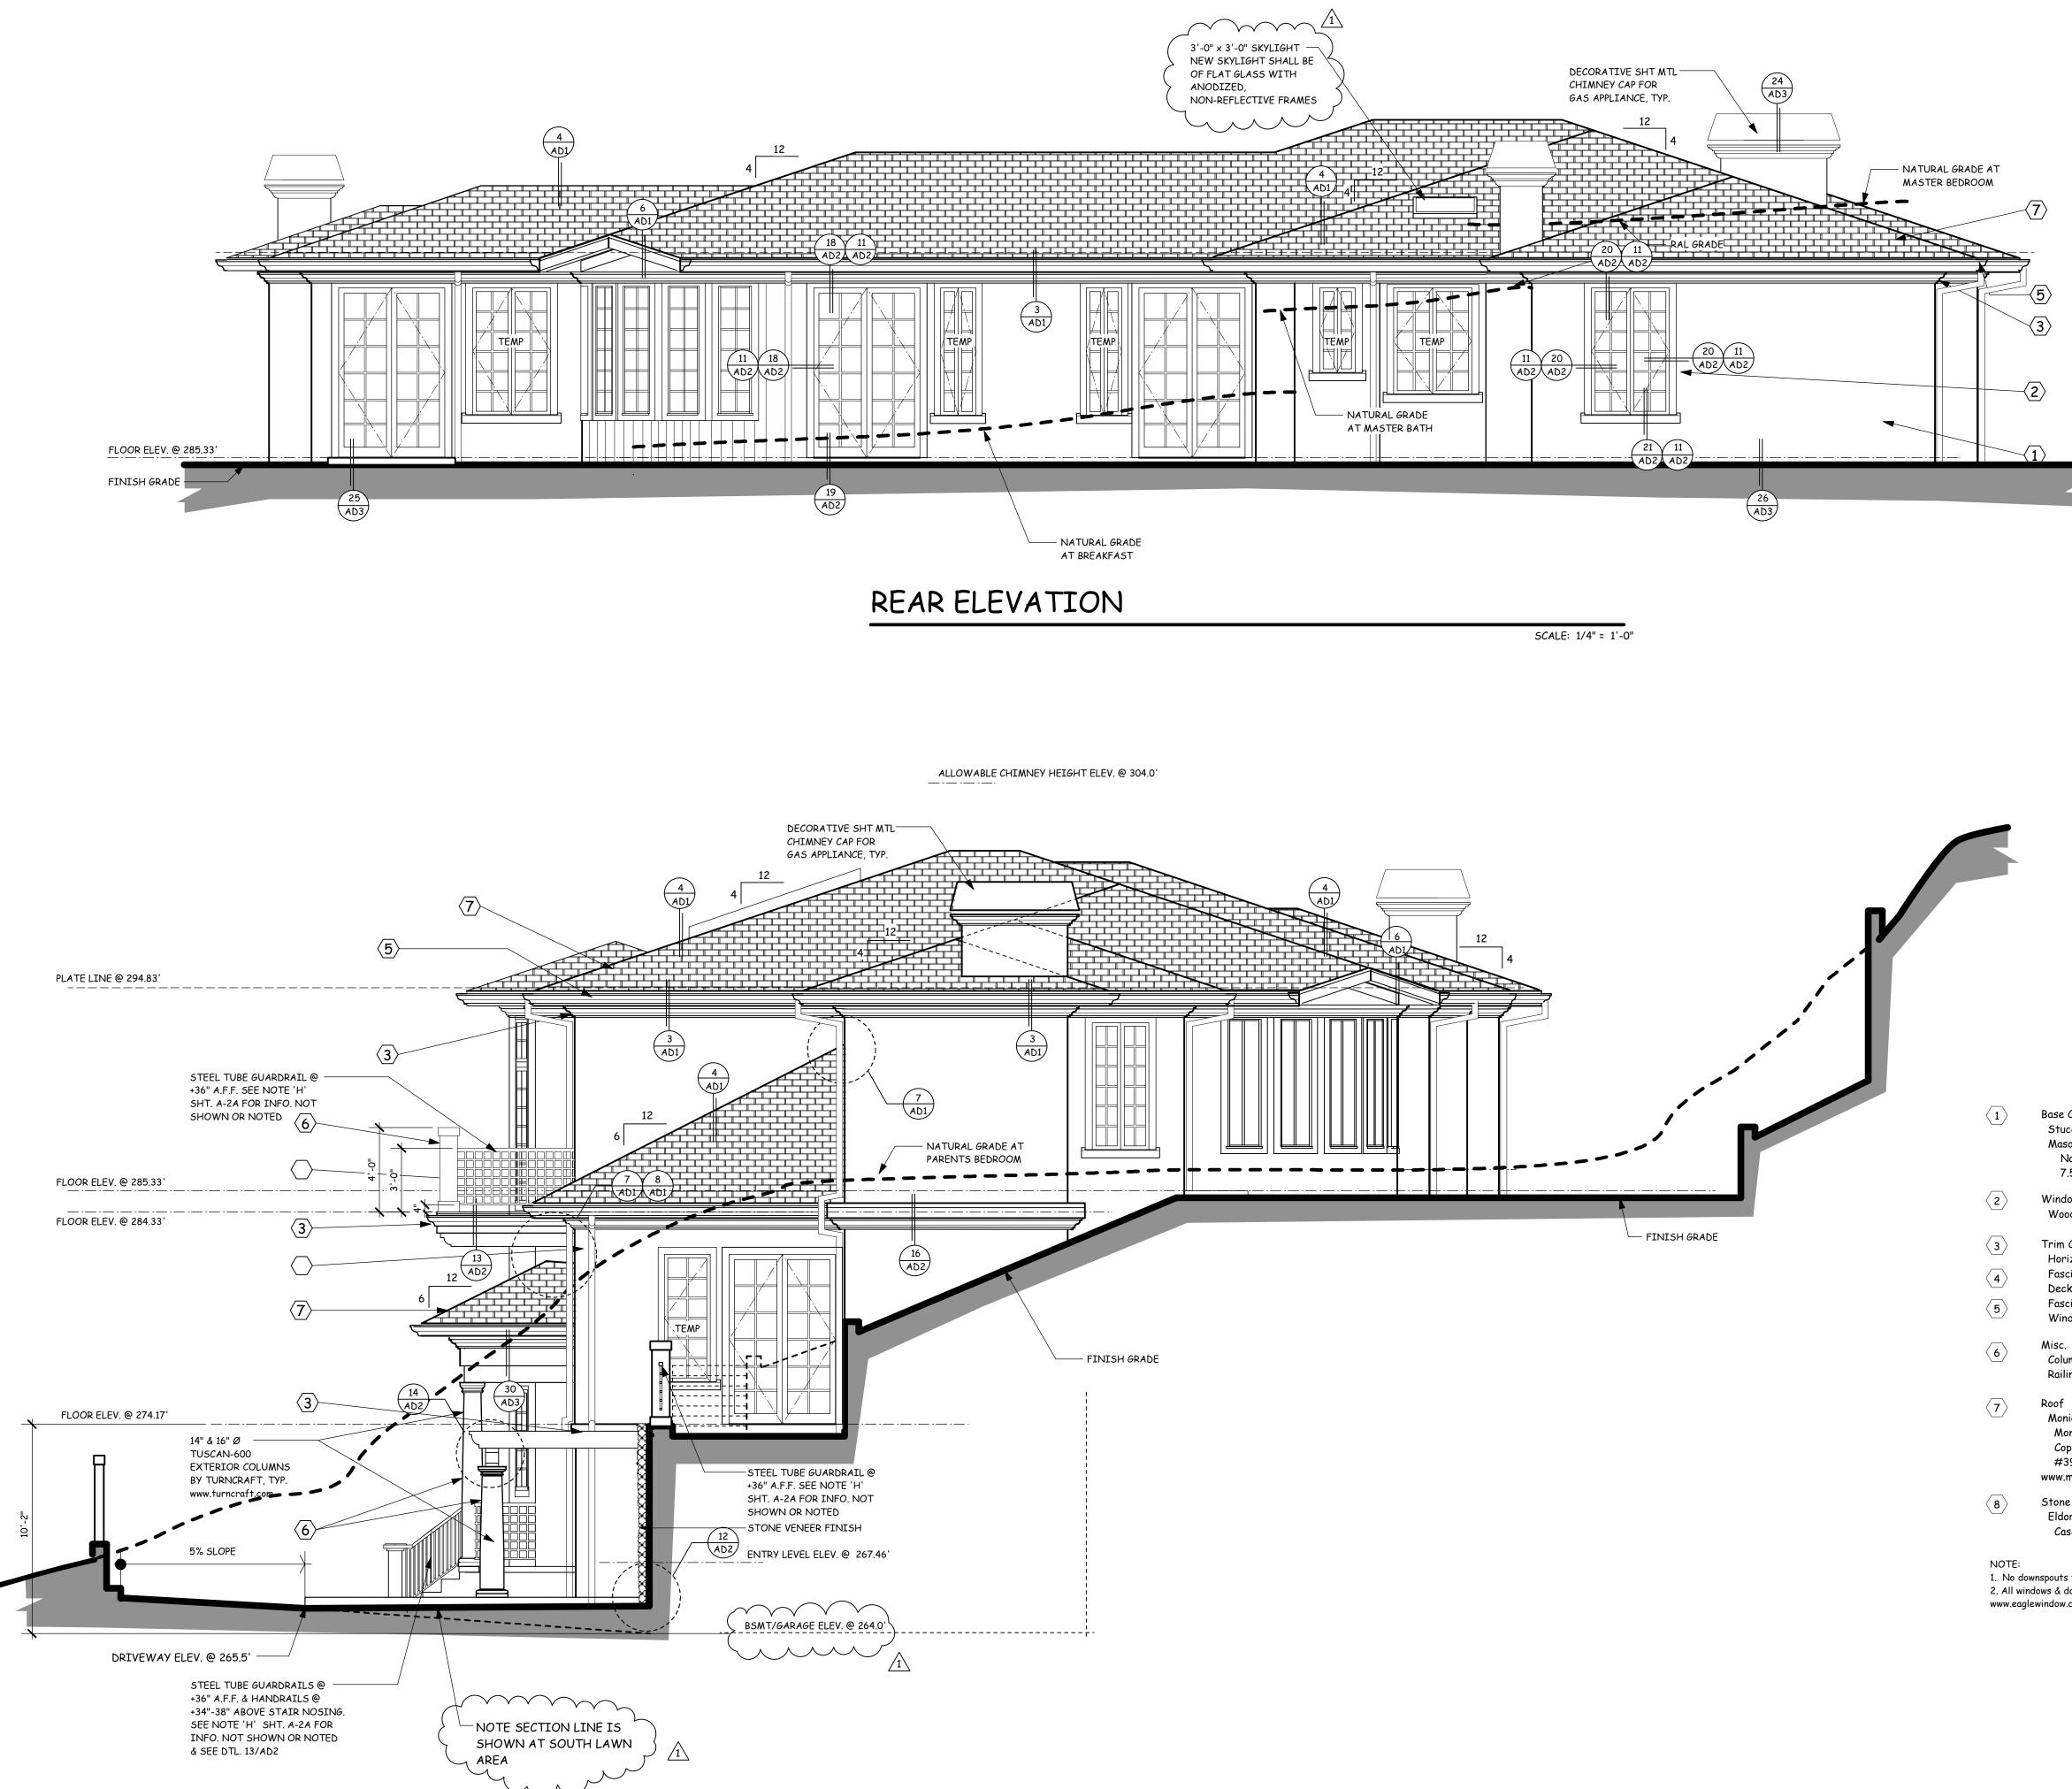

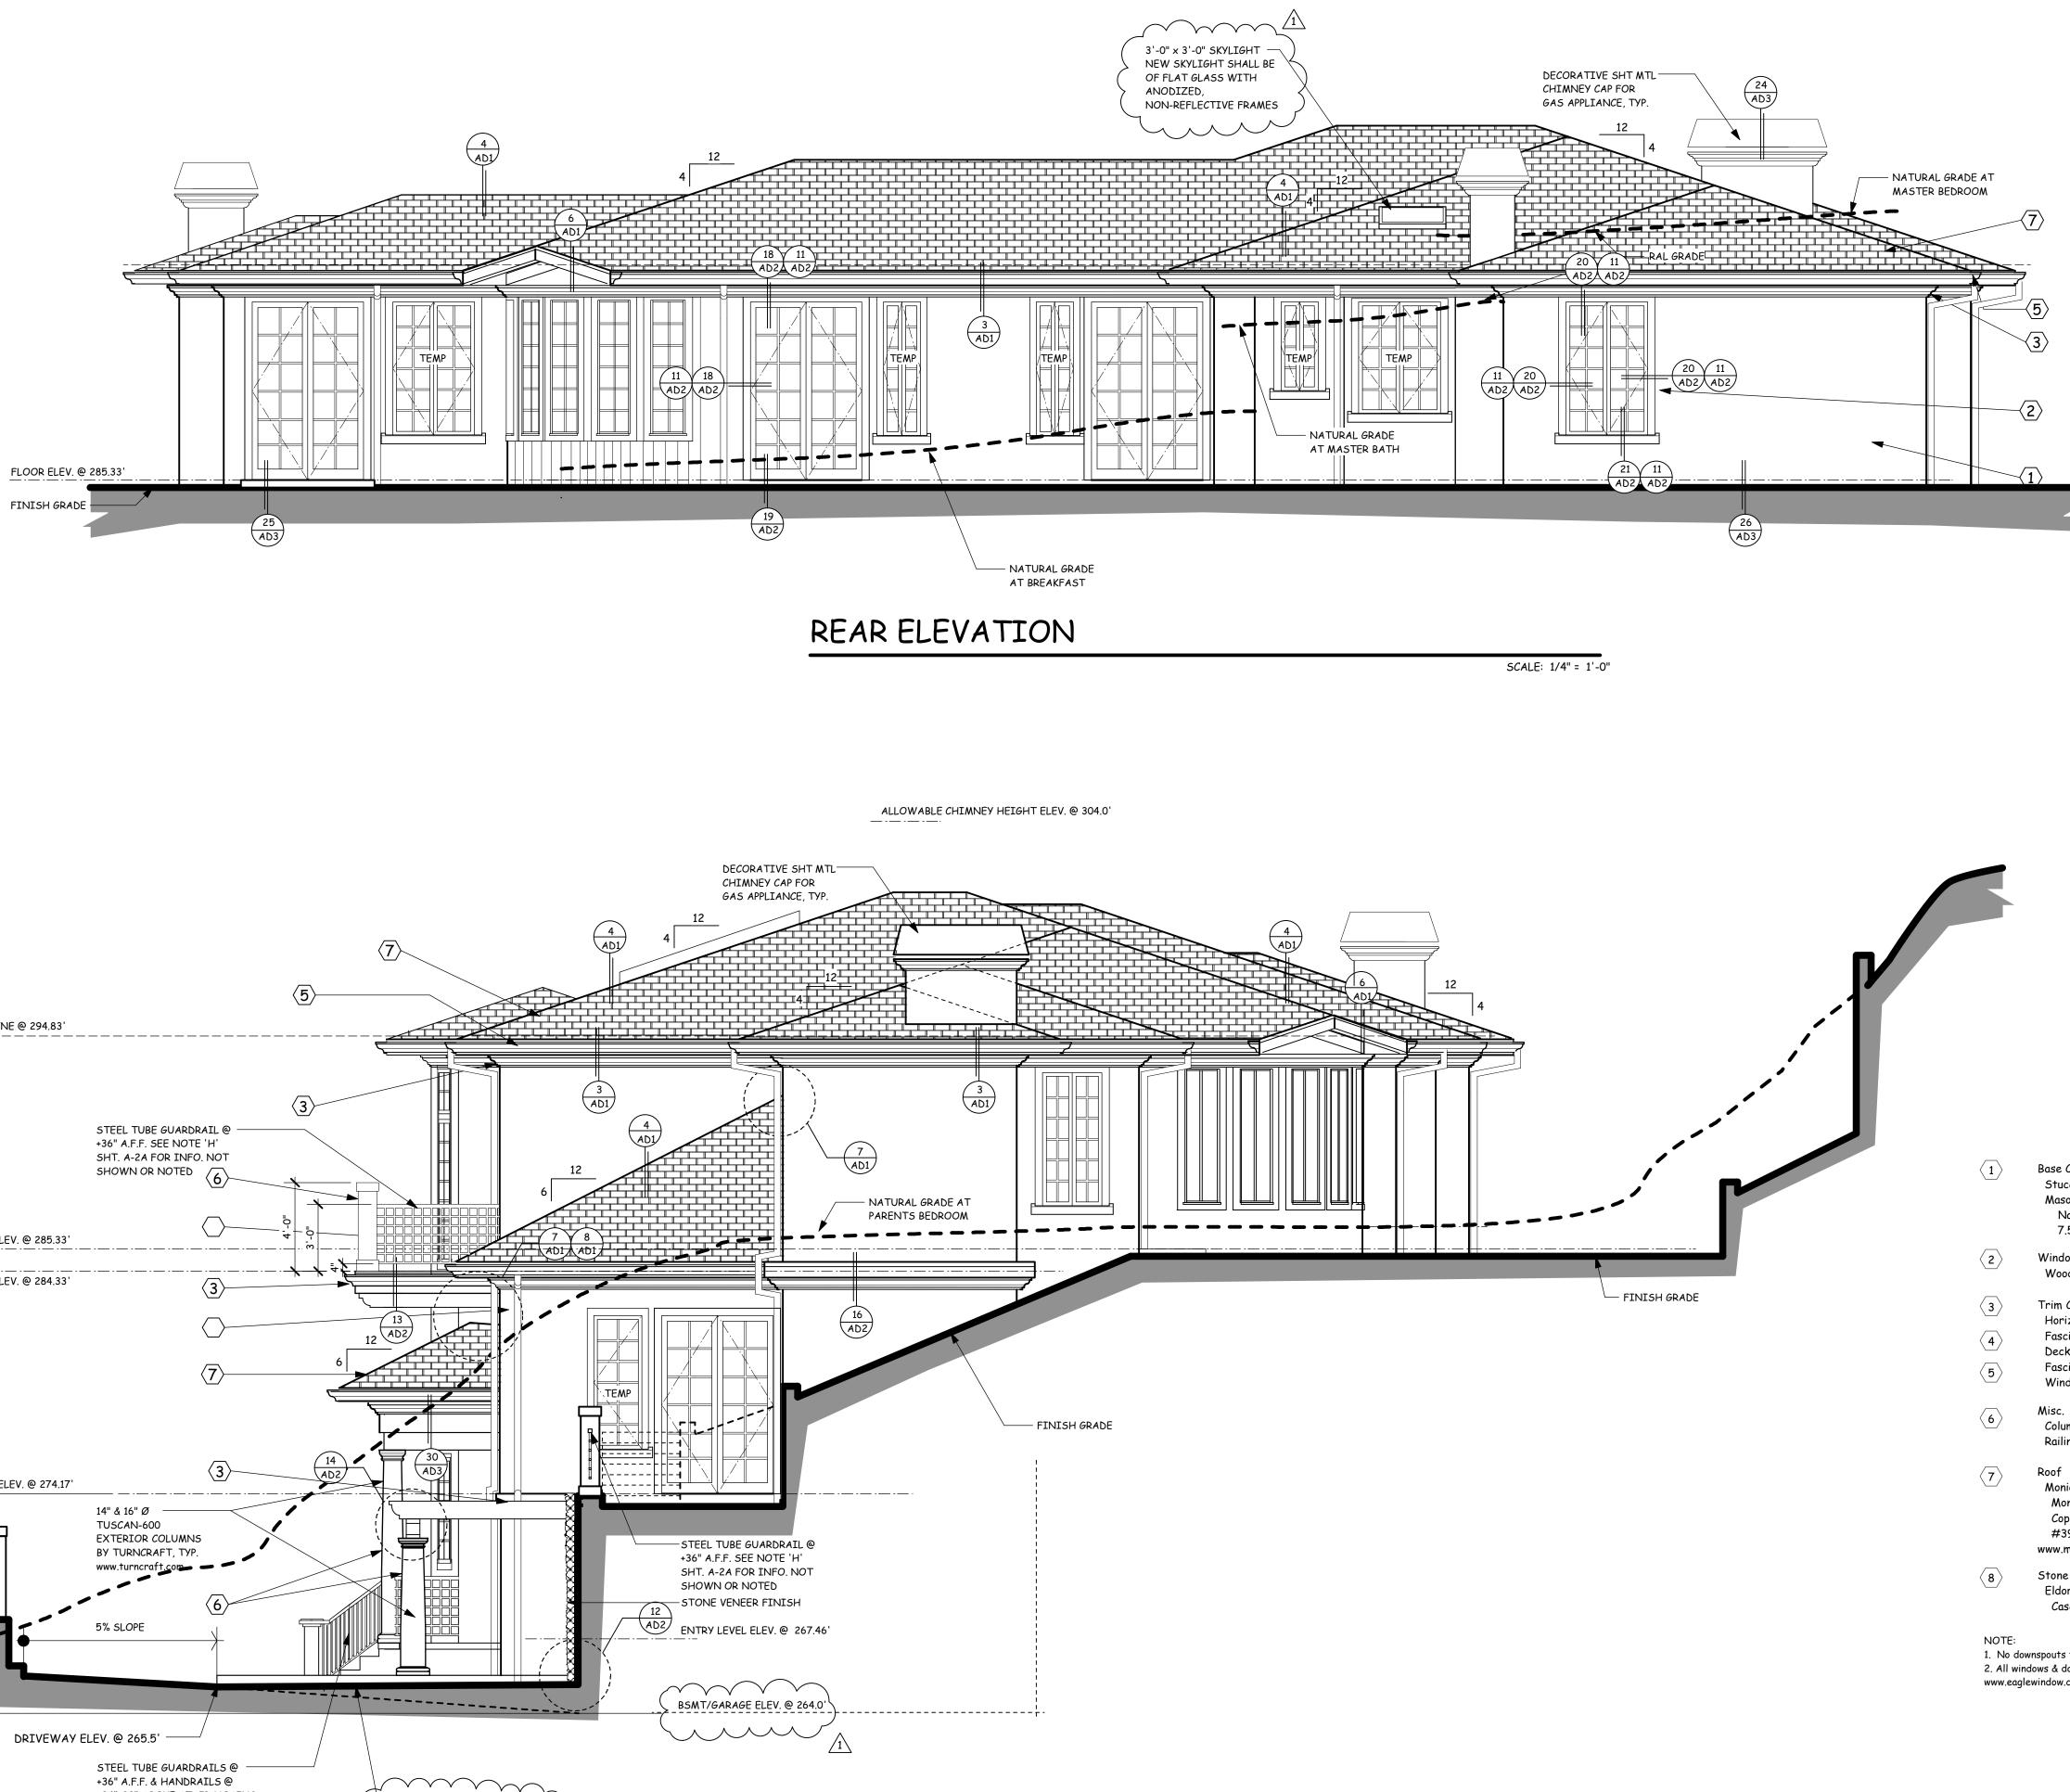



	Sep 22, 2003 me: 9944-#2 Men A.mcd
No.	Revision
1	BUILDING DEPT. COMMENTS Sept. 22, 2003 EGK
2	BUILDING DEPT. COMMENTS Jan. 5, 2004 EGK

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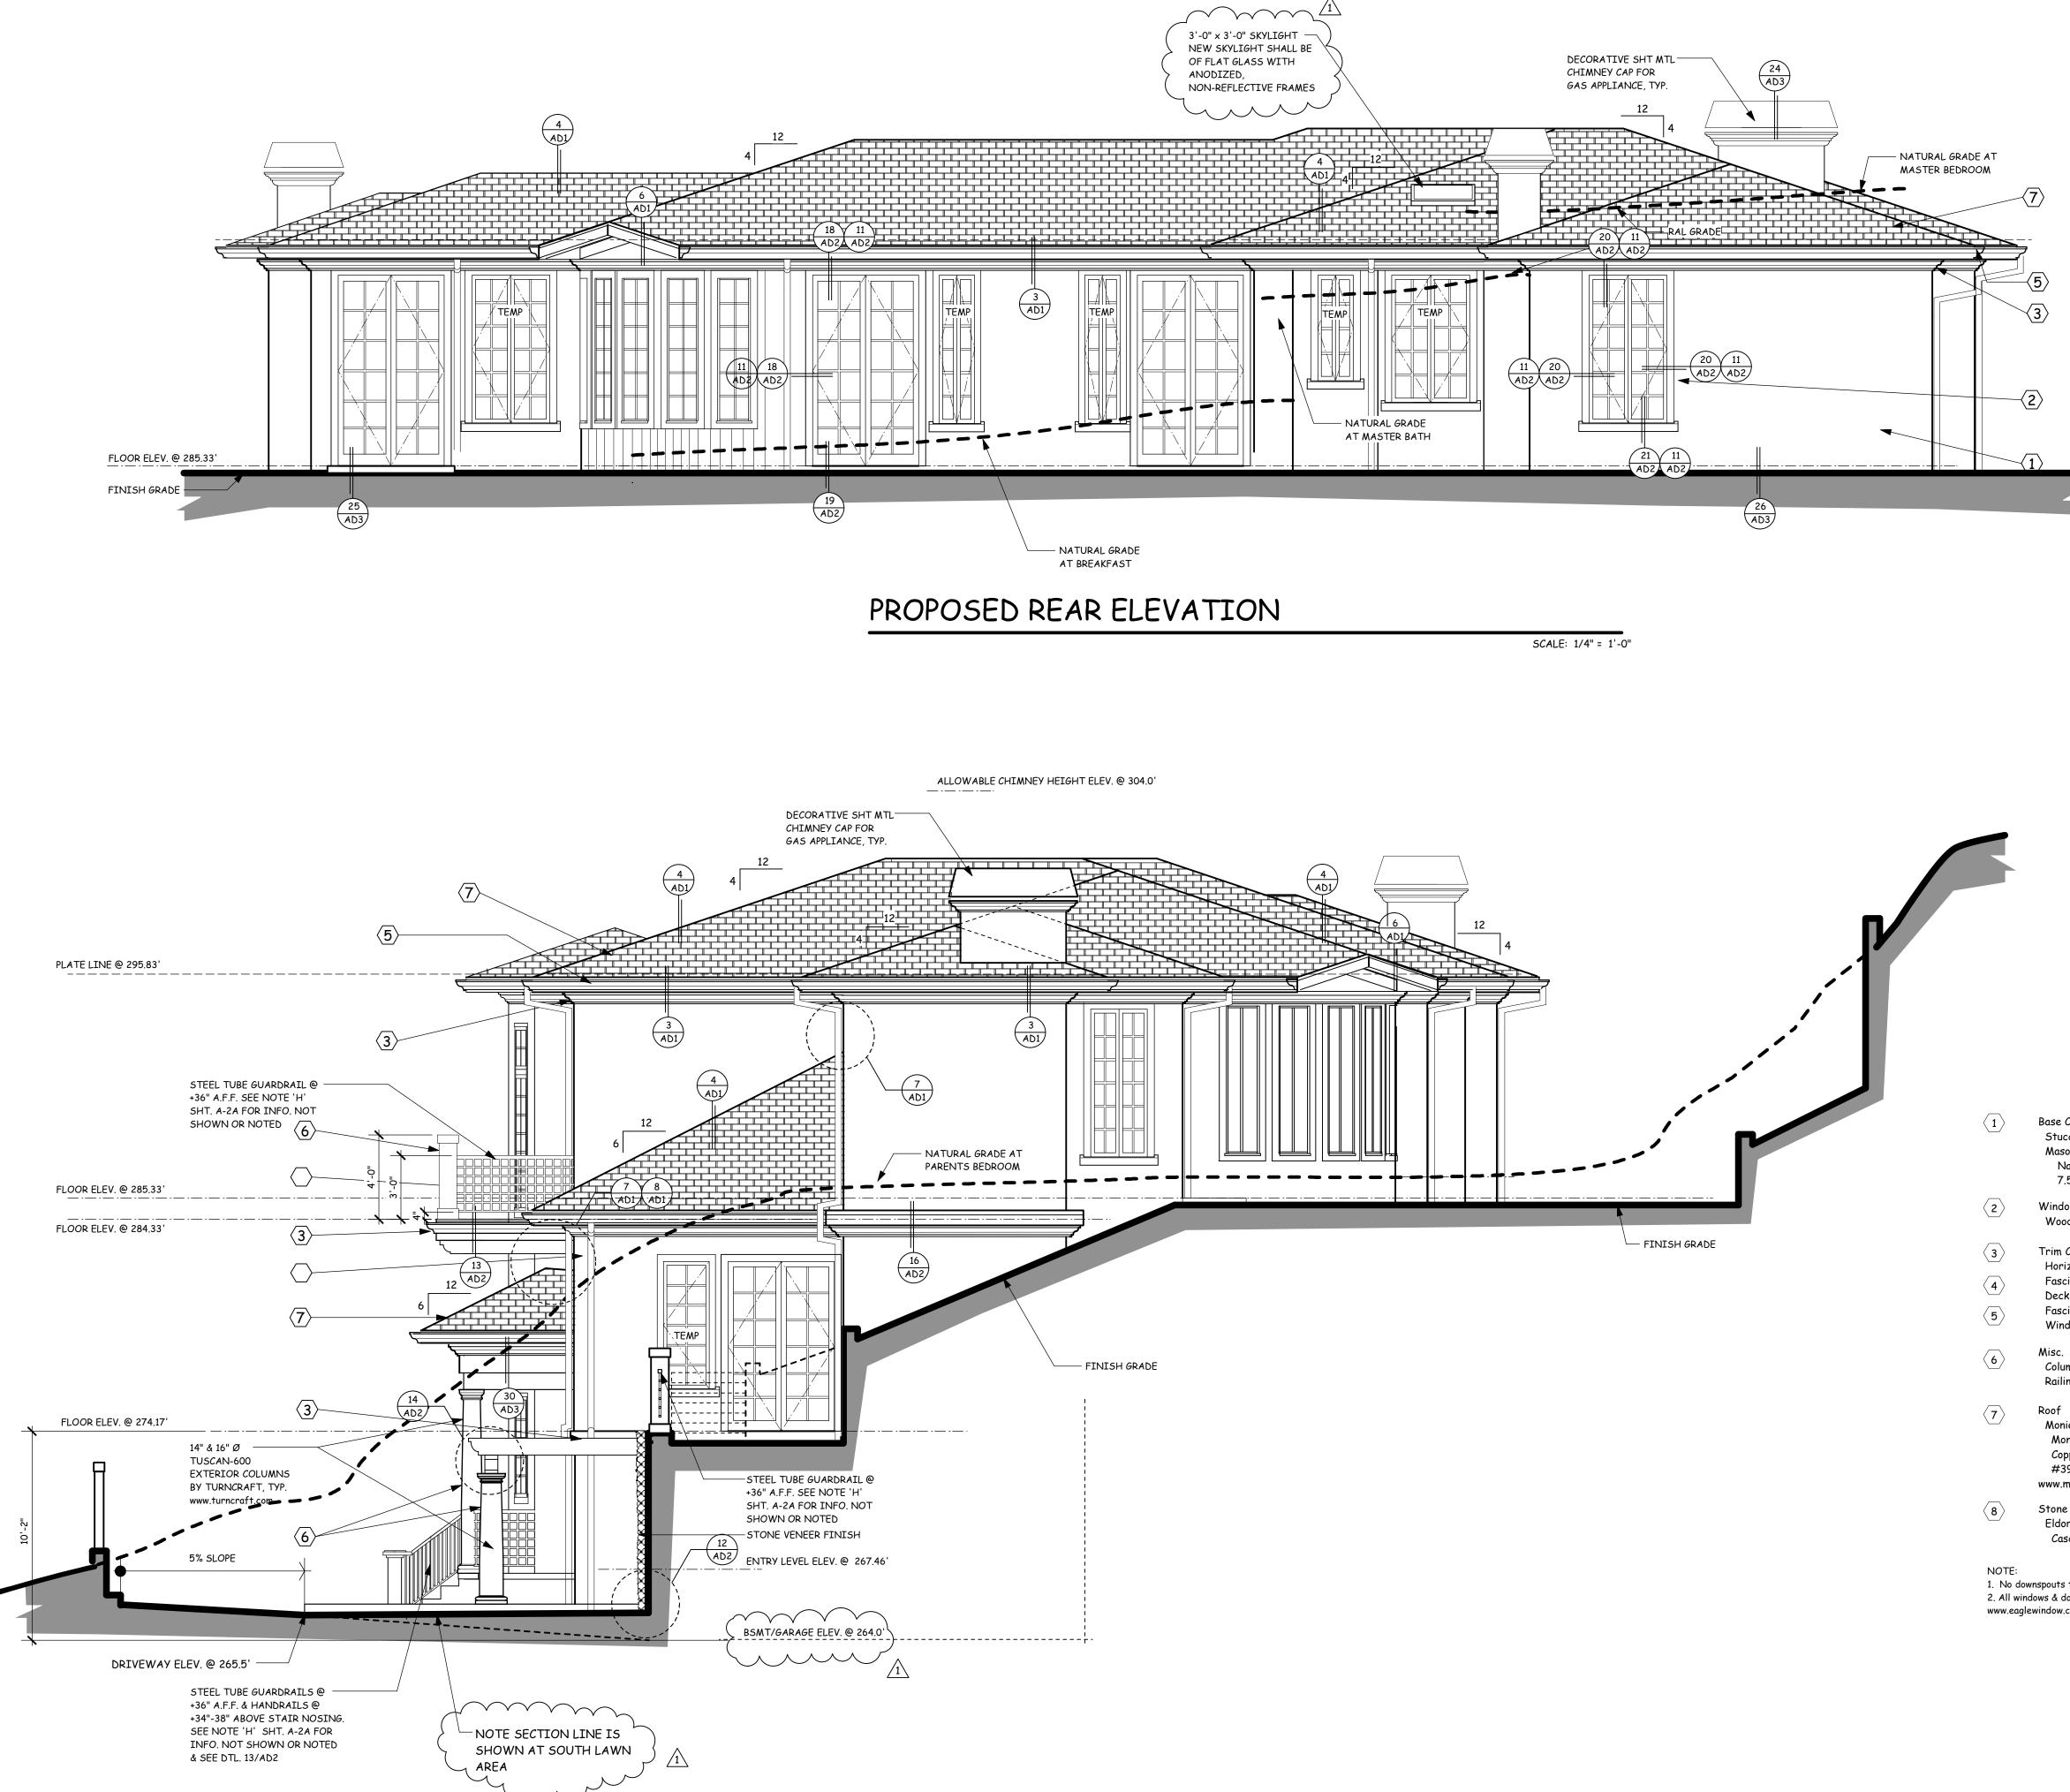
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2	Windows Frames Wood Clad Windows	Kelly Moore KM-589-L		Te	al	1020 Story San Jose, C
		Artiste		\mathbf{k}	Č	P 2
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	Horizonal Trim	Kelly Moore		ą	$\mathbf{>}$	
$\langle 4 \rangle$	Fascia Gutter	KM606-D				
	Deck Gutters	Cola				
$\langle 5 \rangle$	Fascia Board					
	Windows Trim					
\frown	Misc.					
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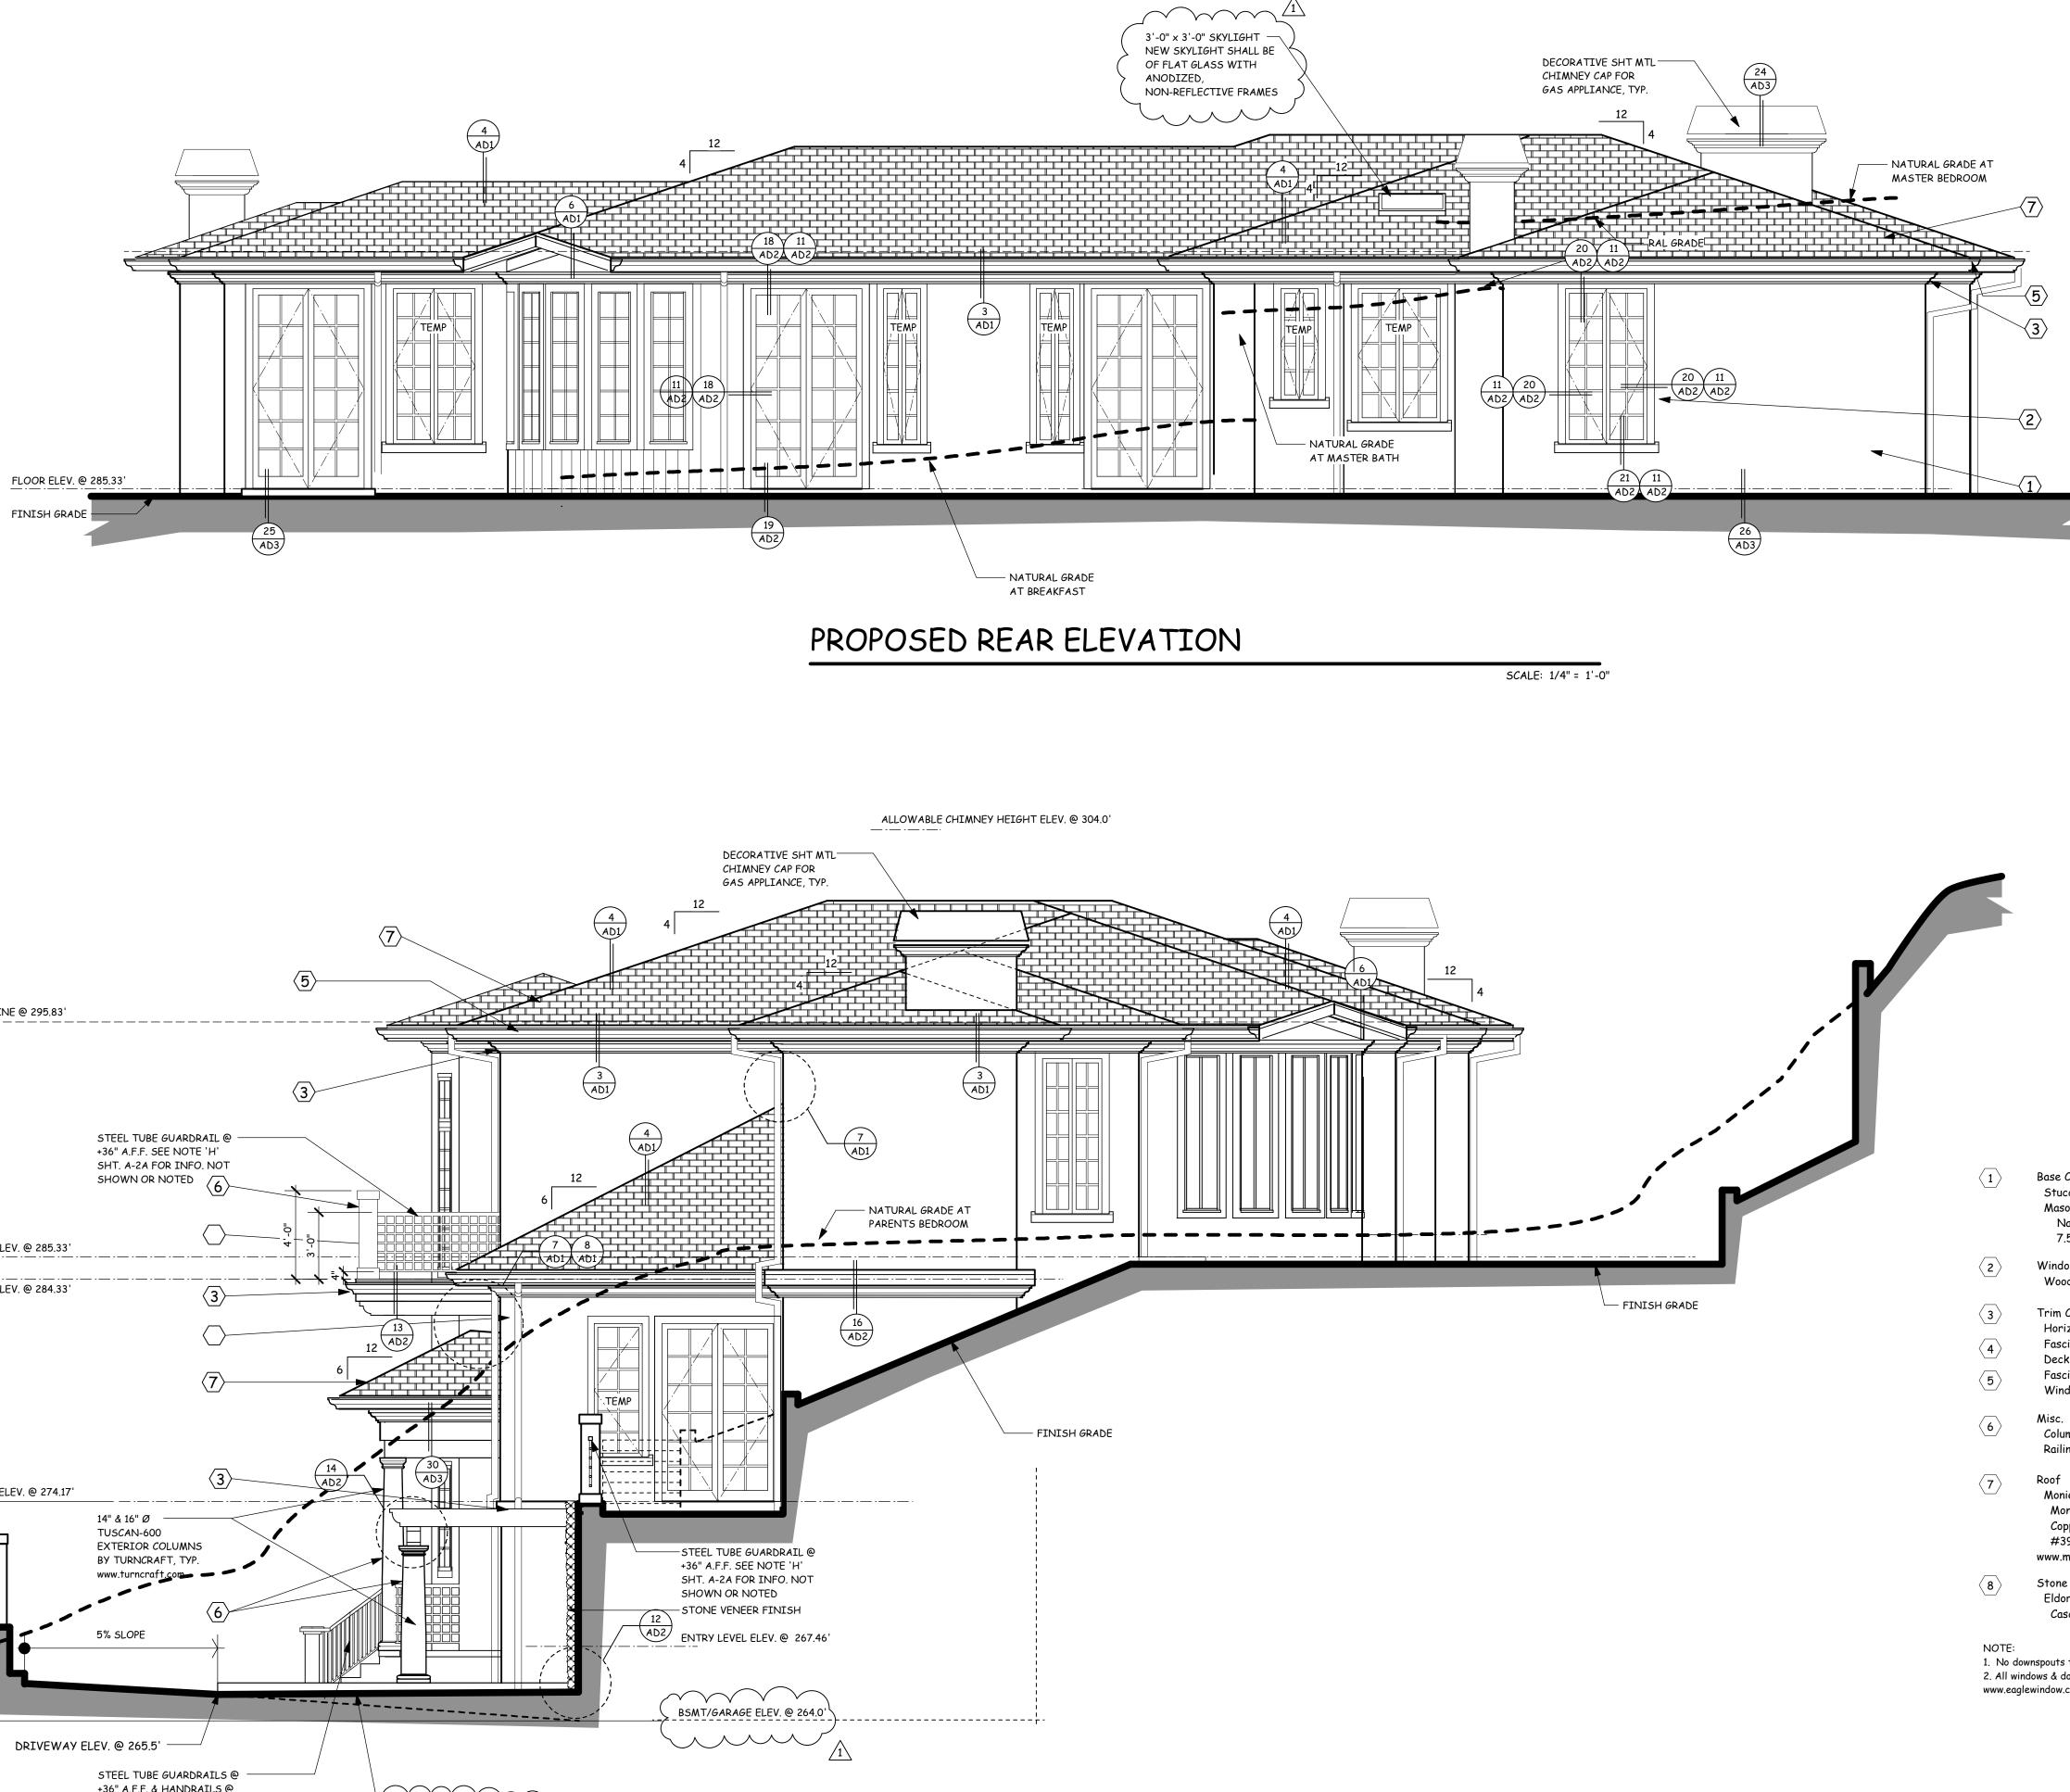
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PROPOSED RIGHT ELEVATION







	Sep 22, 2003 me: 9944-#2 Men A.mcd
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No.	Revision
	BUILDING DEPT. COMMENTS Sept. 22, 2003 EGK
2	BUILDING DEPT. COMMENTS Jan. 5, 2004 EGK

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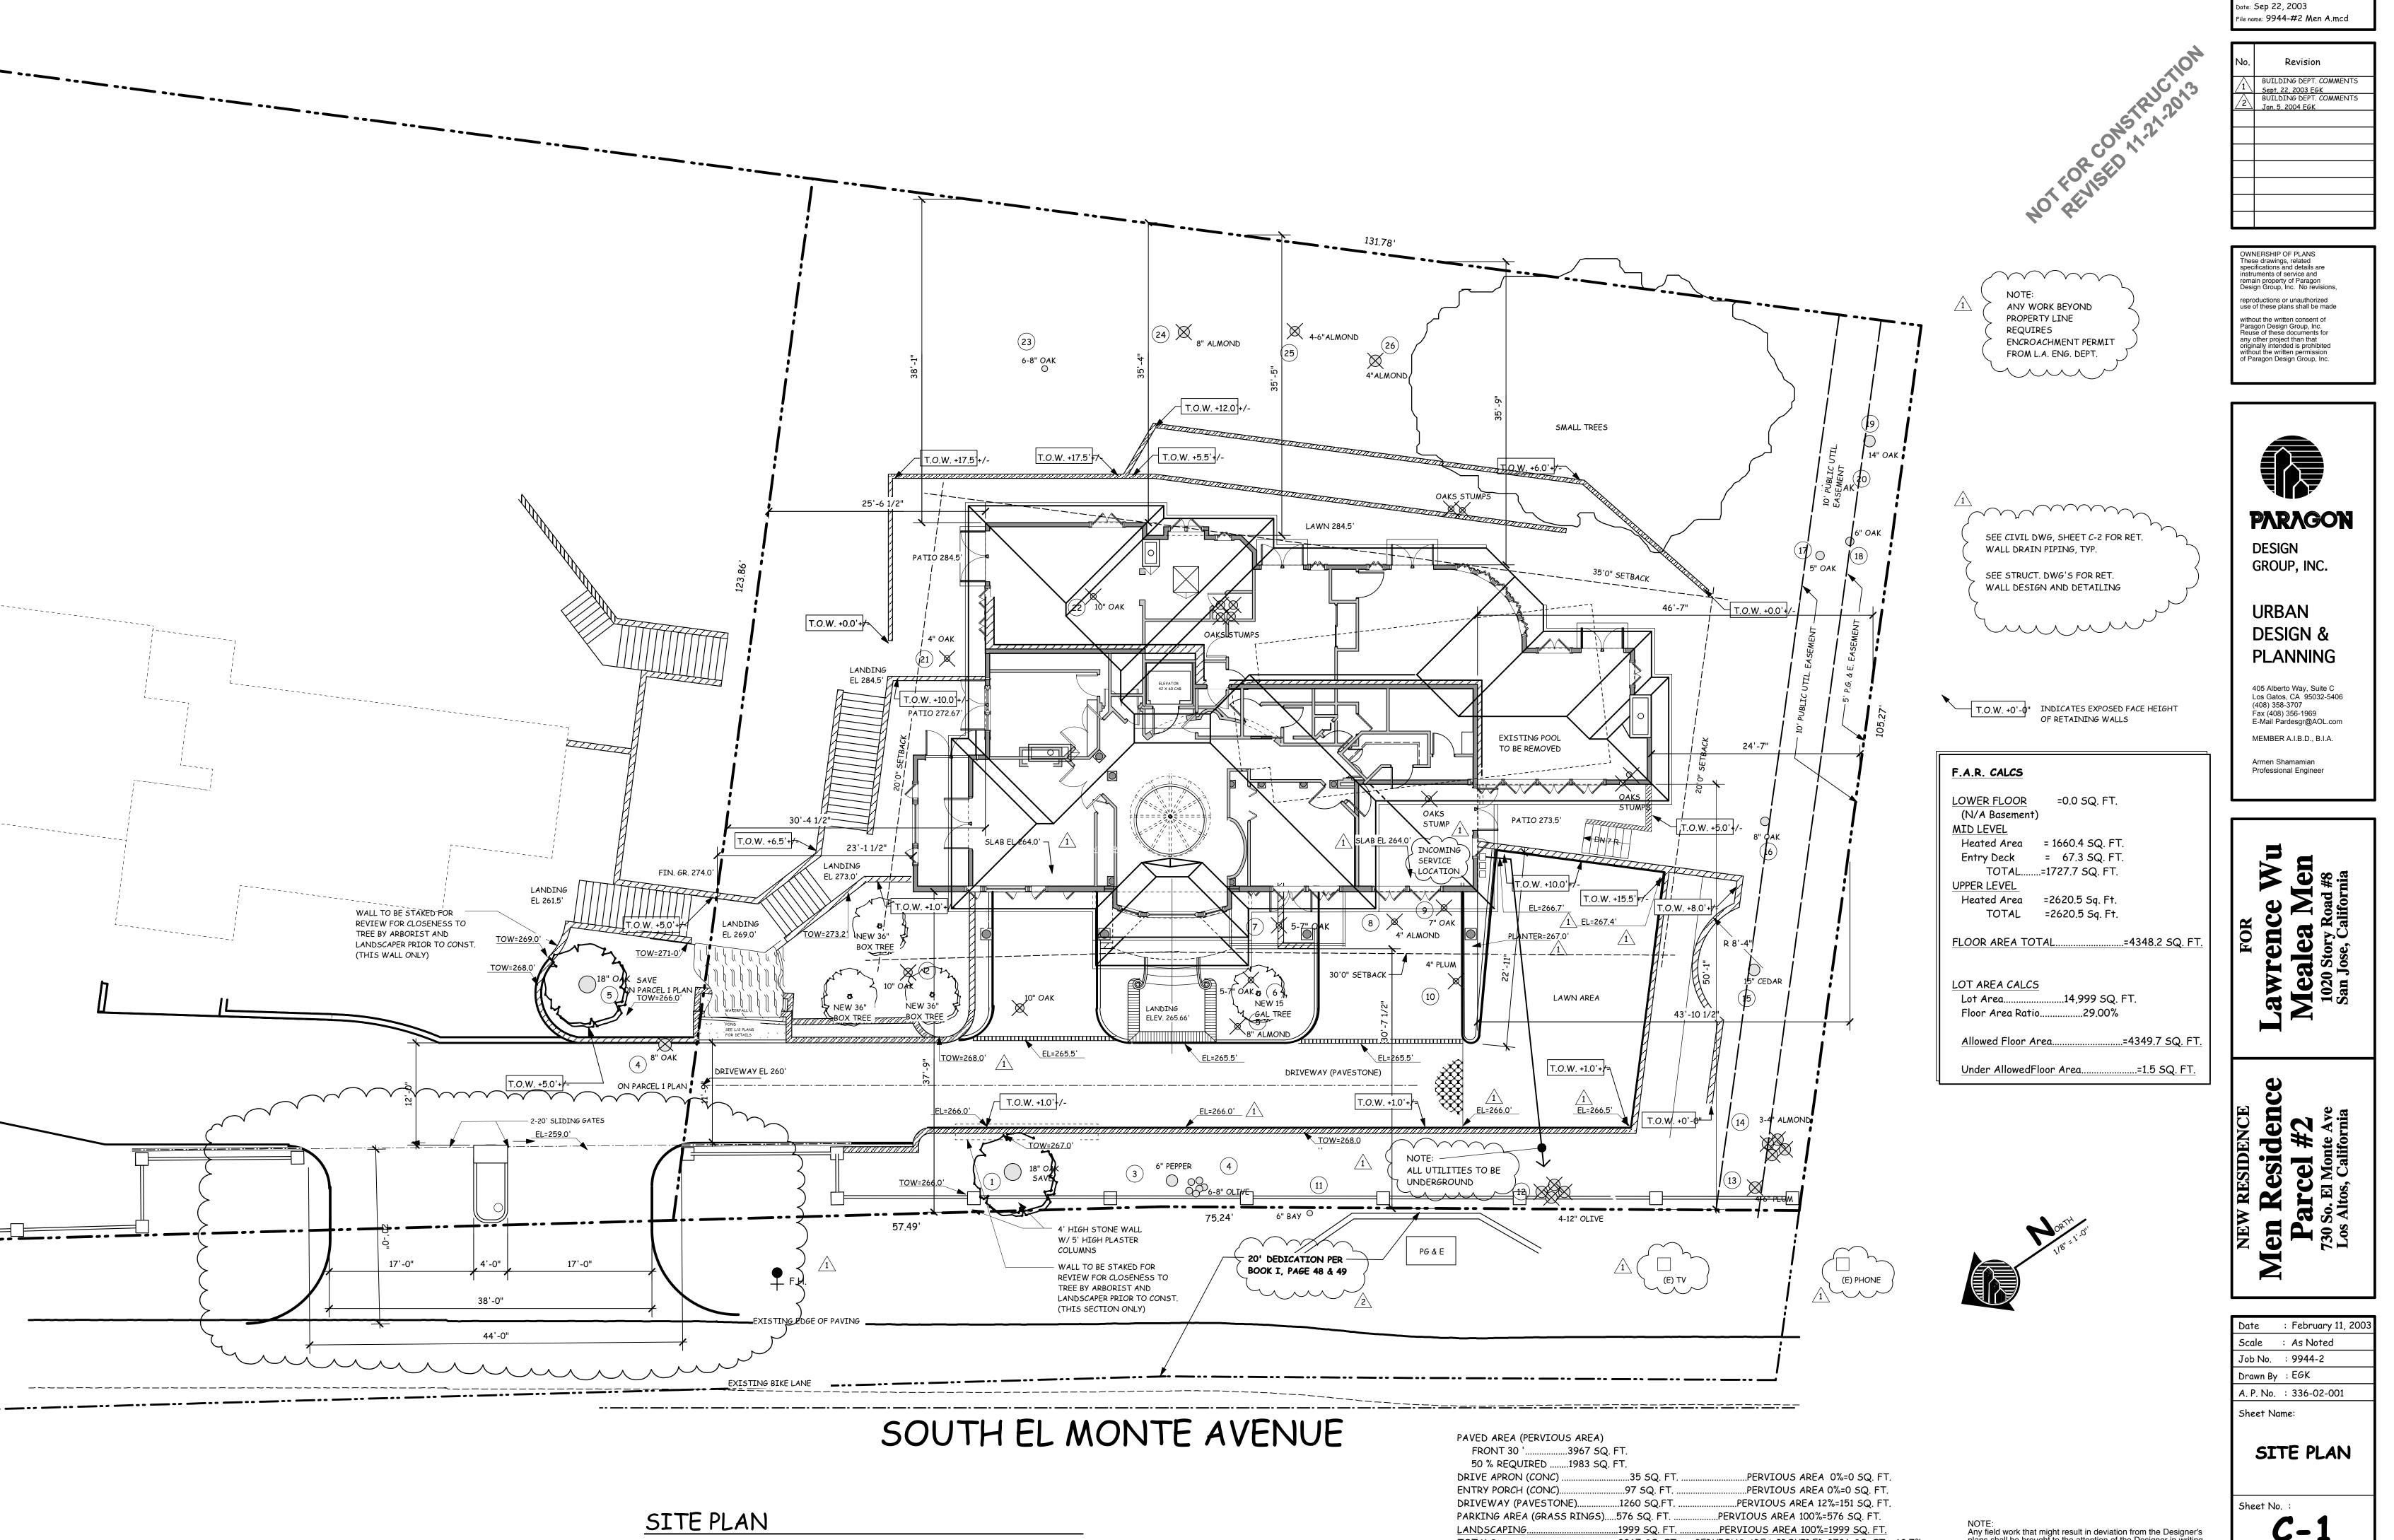
$\langle 1 \rangle$	Base Color Stucco Siding Masonary Veneer Napa Cst Stone 7.5"x15.5" Veneer	Kelly Moore KM599-M Cedar Chest	FOR ence Wu lea Men ory Road #8 e, California
(2)	Windows Frames Wood Clad Windows	Kelly Moore KM-589-L	FOJ AWTEN Mealea 1020 Story San Jose, C
 3 4 5 	Trim Color Horizonal Trim Fascia Gutter Deck Gutters Fascia Board Windows Trim	Artiste Kelly Moore KM606-D Cola	Lav Me
6	Misc. Columns Railing Systems	Kelly Moore KM-592-M Northborough	
(7)	Roof Monier Life Tile Monier 2000 Slate Copper Patina C/T #3964 www.monierlifetile.com	Nor mbor ough	NEW RESIDENCE en Residen Parcel #2 730 So. El Monte Ave Los Altos, California
8	Stone Veneer Eldorado Stone Cascade Rustic Ledge		NEW RECENTES OF THE STATES OF
2. All wir	wnspouts to be terminate @ decks, typ. ndows & doors are by EAGLE WINDOWS & DO lewindow.com or contact a field representative		

NOTE:

Date : February 11, 2003 Scale : As Noted Job No. : 9944-2 Drawn By :EGK A. P. No. : 336-02-001 Sheet Name: REAR & RIGHT ELEVATIONS Sheet No. **A-8**a

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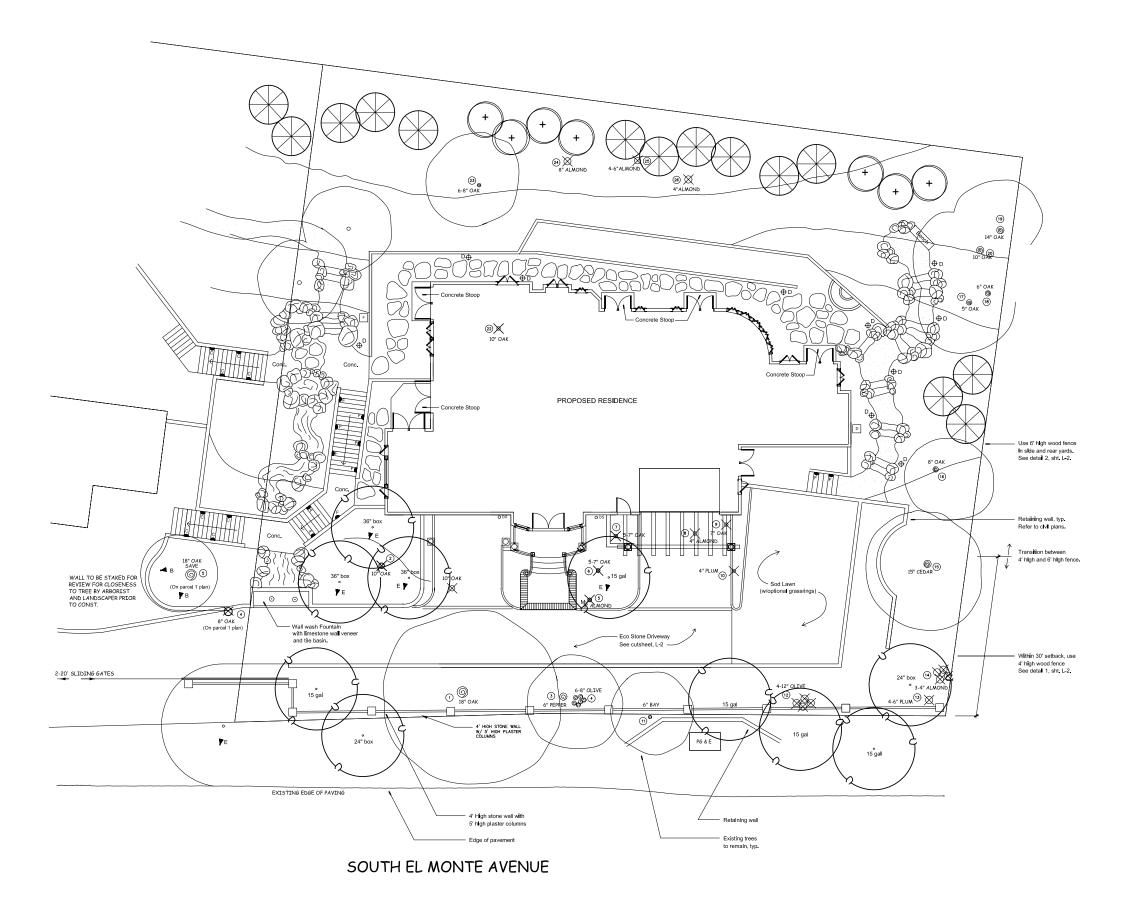
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SITE PLAN

50 % REQUIRED1983 SQ.	FT.	
DRIVE APRON (CONC)	35 SQ. FT	PERVIOUS AREA 0%=0 SQ. FT.
ENTRY PORCH (CONC)	97 SQ. FT	PERVIOUS AREA 0%=0 SQ. FT.
DRIVEWAY (PAVESTONE)	1260 SQ.FT	PERVIOUS AREA 12%=151 SQ. FT.
PARKING AREA (GRASS RINGS)	576 SQ. FT	PERVIOUS AREA 100%=576 SQ. FT.
LANDSCAPING	1999 SQ. FT	PERVIOUS AREA 100%=1999 SQ. FT.
TOTALS	3967 SQ. FT	PERVIOUS AREA PROVIDED.2726 SQ. FT. =68.7%

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LIGHTING LEGEND

SYM	MANUF.	MODEL
\oplus	Vista	2160
٨	Vista	2216
\odot	SPJ	79206600 & 77118100
-	Vlsta	4250
A	Vlsta	MT-
ø	Vista	MT-
#	Vista	MT-
\$		
ф		

DESCRIPTION

12v Path light - Natural copper
12v Tree uplight - Bronze
120V Recessed Fountain Light with
12V stalr light - Bronze
Transformer
Transformer
Transformer
Switch locations
GFCI Locations

SPJ Lighting, Inc. 818.391.4839 cell (800) 469.3637 office Bob Klaldman

Vista Professinal Outdoor Lighting (925) 980 3986 cell (800) 766 8478 office Mike McPherson

LIGHTING NOTES

This plan is a lighting schematic for installation locations and bid allowances. Wire sizing and all circuiting by electrical contractor.

Wires below grade are to be in grey PVC conduit @ 18* deep min. (Except for low voltage lighting where applicable).


All light fixtures to be installed per manuf, specifications and shall comply with all state and local building codes.

Electrical contractor shall verify depths and locations of other utilities prior to trenching or excavation.

All lights shall have photo-cell or timer capacity. Tree up lights shall be on separate circuit from the rest.

Provide as a minimum 3' of extra wire for all path lights and 5' of extra wire for all up-lights.

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Project #: Checked by the residence and the resi		SHEET TITLE:	Scale:	Drawn by:	OWNER :	DWG:		
Project #: Checked by: Wen Kesidence - in Parcel 2 - Bonus: 730 South El Monte Avenue May 2003 Los Altos, CA 94022			.∩- 8= I	ШS		MenResidenceParcel2		
- In Parcel 2 Dete: 730 South El Monte Avenue BONUS: May 2003 Los Altos, CA 94022	NIC.		Project #	Checked by:		1	() Hoag e Lang e Design	
730 South El Monte Avenue Los Attos, CA 94022		Layouvrigning Flan		ŧ	Parcel 2	BONUS:	Landscape Architecture	
Los Altos, CA 94022				Date:	730 South El Monte Avenue		13 F Main Groot Suite B . Les Catris CA 05030	
				May 2003	Los Altos, CA 94022		(408) 354-9509, Fax # (408) 399-0062	

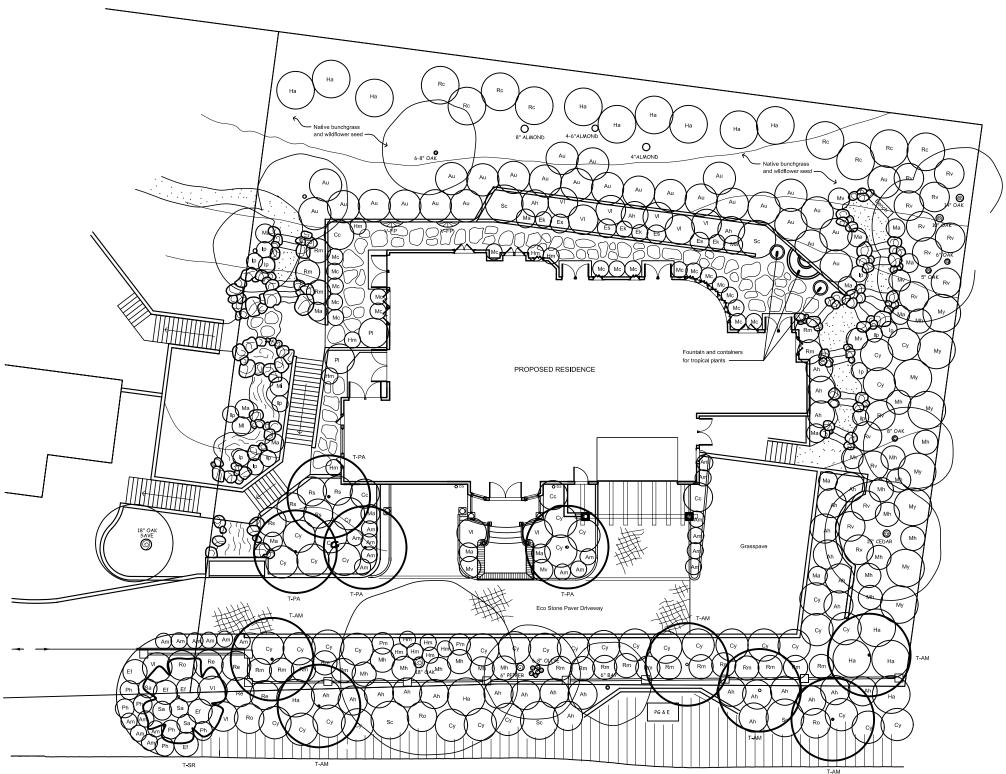

SOUTH EL MONTE AVENUE

PLANTING LEGEND

SYM	BOTANICAL NAME	COMMON NAME	QTY	SIZE
Trees				
T-AC	Aesculus californica	Callfornla Buckeye	1	15 gal
T-AM	Arbutus 'Marina'	Strawberry Tree	10	0
T-PA	Prunus 'Akebono'	Flowering Cherry	6	0
T-PC	Prunus carolInlana	Carolina Bush Cherry	3	0
T-QA	Quercus agrifolia	Coast Live Oak	3	0
T-SR	Syagrus romanzoffianum	Queen Palm	2	0
Shrubs				
Ae	Arctostaphylos 'Louis Edmonds'	Manzanita	1	5 ga
Ah	Arctostaphylos 'Howard McMinn'	Manzanita	44	5 ga
Am	Achillea millefollum	White Yarrow	55	1 gal
Au	Archtostaphylos 'Uva-Ursl'	Manzanita	56	1 ga
Cc	Carpenteria californica	Bush Anemone	7	1 gal
Су	Ceanothus 'Yankee Point'	Carmel Creeper	66	1 ga
Ef	Erlogonum fasciculatum	Buckwheat	8	1 gal
Ek	Erigeron karvinskianus	Santa Barbara Daisy	13	1 ga
Es	Epilobium 'Select Mattole'	Califonia Fuchsia	7	1 ga
Ha	Heteromeles arbutifolla	Toyon	33	5 ga
Hd	Holodiscus discolor	Cream Bush	2	1 gal
Hm	Heuchera maxima	Island Alum Root	29	1 gal
lp	Iris - Pacific Coast Hybrids	Pacific Coast Iris	21	1 gal
Ma	Mimulus aurantiacus	Monkey Flower	50	1 gal
Mc	Murtus 'compacta'	Dwarf Myrtle	27	1 gal
Mh	Mahonia aquifolium	Oregon Grape	18	1 ga
MI	Mimulus cardinalis	Scarlet Monkey Flower	3	1 gal
Mv	Muhlenbergia rigens	Deer grass	2	1 ga
Mv	Monardella villosa	Coyote Mint	19	1 ga
My	Myrica californica	Pacific Wax Myrtle	8	5 ga
Ph	Pentemon 'Margarita Bop'	Foothill Penstemon	12	1 gal
PI	Philadelphus lewisii	Callfornla Mock Orange	3	5 ga
Pm	Polystichum munitum	Western Sword Fern	14	1 gal
Rc	Rhamnus californica	Coffeeberry	14	5 ga
Re	Rhamnus 'Eve Case'	Dwarf Coffeeberry	29	1 gal
Rm	Rhamnus 'Mound San Bruno'	Dwarf Coffeeberry	45	1 ga
Ro	Romney coulter	Matilija Poppy	7	5 ga
Rs	Rhamnus 'Seavlew'	Dwarf Coffeeberry	5	1 ga
Rv	Ribes vibernifolium	Evergreen Currant	28	1 ga
Sa	Sphaeralcea amblgua	Desert Mallow	8	1 gal
Sc	Salvla clevlandl	Sage	7	5 gal
Ss	Salvla spathacea	Hummingbird Sage	4	1 gal
VI	Verbena Illacina 'De La Mina'	Cedros Island Verbena	11	1 gal
Vines				
V-Fp	Flcus pumlla	Creeping Fig	0	1 gal

